

CITY OF PACIFIC GROVE

300 Forest Avenue, Pacific Grove, California 93950

AGENDA REPORT

TO: Chair Steres and Members of the Architectural Review Board

FROM: Wendy Lao, Associate Planner

MEETING DATE: August 8, 2017

SUBJECT: Architectural Permit (AP) & Tree Permit with Development (TPD) #17-

507 for a property located at 1149 Forest Avenue to allow exterior changes, including a two-story addition of 1,540 gross square feet at the center of the property; and the demolition of a garage at the rear of the property to be replaced with a two-story addition of 1,400 gross square feet; and siding material and window upgrades to the existing buildings in the front and the center of the property. The completed project

proposes a total of eleven (11) parking spaces, the removal of an Eucalyptus tree, and a replant of one Coast Live Oak tree on site.

ADDRESS: 1149 Forest Avenue (APN 006-713-024)

ZONING/ C-FH (Commercial-Forest Hill)/Commercial

LAND USE:

APPLICANT: Mark Abrahams

CEQA: Categorical Exemption, Section 15301(e)(2), Class 1

BACKGROUND

On May 30, 2017, Mark Abrahams, property owner, applied for an Architectural Permit and Tree Permit with Development #17-407 for a property located at 1149 Forest Avenue in Pacific Grove. The Architectural Permit would allow siding material changes and window upgrades to the two existing buildings (1155 Forest Avenue in the front of the property, and the duplex 1145/1147 Forest Avenue at the center of the property). The Architectural Permit would also allow a new 2-story building of 1,540 gross square feet (New Building #1) to be located near the center of the property, which would include a 3-car garage on the lower floor and one 1-bedroom apartment unit upstairs. Lastly, the Architectural Permit would also allow the demolition of a garage at the rear of the property, to be replaced with a new 2-story building of 1,400 gross square feet. Similarly, this building (New Building #2) also includes a 3-car garage on the lower floor, and one 1-bedroom apartment on the upper floor.

To accommodate New Building #1, a Tree Permit with Development would be required in order to remove an existing Eucalyptus tree. A replant of a Coast Live Oak would be required to be planted elsewhere on site.

DISCUSSION

Zoning Code

The proposed development would be in conformance with all requirements of the C-FH zone, including but not limited to site coverage, height, and parking requirements.

The proposed project would have a site coverage of 71%, which is within the allowable maximum site coverage of 75%, pursuant to P.G.M.C. 23.31.040. The proposed project would have a building height of 22 feet, which is within the allowable maximum height limit of 35 feet.

The proposed project would have 11 parking spaces when completed, of which 6 are covered and 5 are uncovered. This is below the minimum parking requirement of 12 parking spaces, pursuant to P.G.M.C. 23.64.190(b) and (e). However, the property is located in the Commercial-Forest Hill (C-FH) zoning district, and at least one space may be a Shared Space, with a sign that shall state "No Parking Between 6pm-7am, except for residents", or similar. This will satisfy the requirement of 12 parking spaces.

Architecture Review Guidelines:

The project proposal appears to adhere to the following Architectural Review Guidelines:

Guideline #28: An addition should complement and balance the overall form, mass, and composition of the existing building.

The project proposes to have an addition of two new smaller buildings located behind an existing 2-story building, and will not be visually significant from the street.

Guideline #29: Design new roofs to appear similar in scale to those seen traditionally in the neighborhood.

The project proposes to have gable roofs with asphalt shingles for the two new buildings, which is consistent with the existing buildings on site.

Guideline #35: Design a façade to appear similar in scale and character to those in its context.

The project proposes façade improvements to the existing building at 1155 Forest Avenue. This includes the addition of architectural details such as trims to break up an otherwise blank façade, and the use of varying materials and a combination of vertical and horizontal elements to soften the elevation.

Tree Removal

The project proposes to remove a multi-stemmed Eucalyptus tree. A Tree Resource Assessment was completed by Frank Ono, ISA Certified Arborist #536, and recommended a tree replant of a Coast Live Oak.

Housing Element

The project seeks to add two additional apartment units on site, which appears to support the following City of Pacific Grove's Housing Element Goals and Policies:

Goal #2: Provide diverse, high quality housing choices appropriate for residents at all income levels.

Policy 2.1: Strive to accommodate the City's share of the region's housing needs.

Policy 2.3: Encourage affordable housing development...

Goal #3: Reduce governmental and infrastructure constraints to the improvement and development of housing for people of all income levels.

Policy 3.3: Ensure that City policies, regulations, and procedures do not add unnecessarily to the time or cost of producing affordable housing, while assuring the attainment of other City objectives.

Environmental Determination:

The project qualifies for a Class 1 exemption from CEQA requirements, pursuant to Section 15301(e)(2) – Existing Facilities. The proposed addition and alterations do not present any unusual circumstances that would result in a potentially significant environmental impact. The proposed alterations do not constitute a substantial adverse change to the environment, thus conforming to the requirements of the California Environmental Quality Act (CEQA).

ATTACHMENTS

- A. Permit Application
- B. Project Data Sheet
- C. Draft Permit
- D. Tree Report
- E. Window Details
- F. Project Plans

Wendy Lao	
Wendy Lao, Associate Planner	

RESPECTFULLY SUBMITTED:

CITY OF PACIFIC GROVE

Community Development Department – Planning Division

300 Forest Avenue, Pacific Grove, CA 93950

Tel: 831.648.3190 • Fax: 831.648.3184 • www.cityofpacificgrove.org/cedd

Permit Application

Application #

Date:

Total Fees:

	t Citita i defense	41.01.				
	Project Address: 1149	Forest Au Pacis	hic Grave APN: 066-7/3-024			
	Project Description: Reporte interior & Exterior of Both Building. Reconstrut					
	tle	garage, Modify	Front building to look like lear build	my		
OWNER:	replace windows, n	en stocco ad trin	h.	J		
	Tree Work? □ Ye					
APPLICANT/OWNER:	Name: MARK Abrahams Phone: 707 815 9324 Email: abrahams mark 20 Gmal. Car		Name: KA Rosidential LCC Phone: 787 815 9324 Email: abrahans Mark 2 & Gml C			
	Mailing Address: 225 C		Mailing Address:			
	CARME (a					
	Permit Request: CRD: Counter Determination AP: Architectural Permit AP: Administrative AP ADC: Arch Design Change ASP: Admin Sign Permit	☐ SP: Sign Permit ☐ UP: Use Permit ☐ AUP: Administrative UP ☐ ADU: Acc. Dwelling Unit ☐ LLA: Lot Line Adjustment	□ LM: Lot Merger □ PUU: Undocumented Unit □ IHS: Initial Historic Screening □ VAR: Variance □ HPP: Historic Preservation □ MMP: Mitigation Monitorin □ A: Appeal □ Stormwater Permit □ TPD: Tree Permit W/ Dev't □ Other:	ng		
PLANNING STAFF USE ONLY:	CEQA Determination: Exempt Initial Study & Mitigated Negative Declaration Environmental Impact Report	Review Authority: Staff HRC ZA PC SPRC CC ARB	Active Permits: Overlay Zones: Butterfly Zone Coastal Zone Active Code Violation Permit #: Environmentally Sensitive Habitat Area (ESHA)			
	Property Information Lot: ZC: Historic Resources Inventor	Block:				
	Staff Use Only: Received by:	MAY 3 0 2 20 PAM	petention zone 1			
	Assigned to:	ITY OF PACIFIC GRO	VE 5 3209.30 5-30-17			
			and certify that I am the applicant for this request, that the proper rein, including all documents and plans submitted in connection wi			

this application, are true and accurate to the best of my knowledge.

I further acknowledge it is my responsibility to determine whether additional permits are required.

Applicant Signature: _

Owner Signature (Required):

Updated: 04/20/2017

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CITY OF PACIFIC GROVE

Community & Economic Development Department - Planning Division

300 Forest Avenue, Pacific Grove, CA 93950

Tel: 831.648.3183 • Fax: 831.648.3184 • www.cityofpacificgrove.org/cdd

Permit & Request Application for Tree Permit (TP)

Post:
Pull:
Replant:
Tree Health:
Arborist Report Required:
App.#: TPD 17-0250
Fee: 275,00

1-13-17

Tree Inspection Liability Disclosure: The City shall not be responsible for any damage to property or persons caused by, or related to, trees located on private property. It is the owner's responsibility to maintain all trees on their property in a reasonable and safe manner, and any inspection performed by the City is a limited advisory assessment only. For a more thorough inspection, the owner should contact a certified arborist.

All tree work within the City of Pacific Grove requires an application to be on file.

A permit will be issued based on the City of Pacific Grove Tree Ordinance 12.20.040 Pruning and Removal of Protected trees.

Property Address: 1147 Forest Au	RECEIVED				
Owner: KAROSIDELU LLC	Applicant: Mank Abrohams				
Phone: 707-8159324	Phone: JUL 1 3 2017				
E-mail: abrahamsMankze(mai)	E-mail:				
Tree # Type/Species Evc. algebra	Requested Action: (trim, remove) COMMUNITY DEV D Aerose to Accomidate were Structure				
*Attach additional sheets if required for above listings.	Trimming less than 25% of tree OR branches are less than 6" Dead Tree				
Reason for Request (Please provide brief description. Details may f	ollow in the report)				
Remove to Accomedate addition	Structure				
The following conditions must be met prior to any tree removal or trimming: 1. NO WORK IS PERMITTED until you have picked up and paid the application fee for an approved permit for tree work. 2. A live tree request for removal requires an arborist report and tree hazard evaluation form completed by a Certified Arborist and submitted with this application. 3. All tree work activity shall comply with the provisions of the PGMC Title 12, Trees and the Urban Forest. 4. A site plan must accompany the application showing the location of the trees to be worked on and the location of replants. 5. Substantial Pruning or Removal of any Protected Tree requires a permit except in an Emergency, in compliance with PGMC 12.20.040 6. All trees to be removed must be marked with a bright ribbon around the trunk of the tree. 7. After the permits have been received and processed, the City Arborist will do a site visit and post the permit at the job site for 10 working days. 8. Any protected tree removed must be replaced with a 1:1 ratio of species approved by the City Arborist within 60 days of removal. 9. Permits expire 60 days after its effective date. The City Arborist may grant up to one extension not to exceed 30 days. *This list is not comprehensive of all conditions that may be required for tree removal and trimming work. This particular tree permit is Exempt - CEQA Exemption Class 4s.15304 Minor Alterations to Land.					
I request to pay in lieu fees (\$735/tree) in place of replanting *Request will be approved or denied by the City Arborist	trees, in the amount of \$				
I have read and agree with the conditions of this application an property.	d hereby grant permission for City Personnel to inspect the trees on my				
I, KA/es ded (CC authorize Man La (Agent Name)	to represent me in the application and processing of this permit.				
Owner Signature	#/13/17 Date				
	Revised 7-3-17				



CITY OF PACIFIC GROVE

Community Economic Development Department - Planning Division

300 Forest Avenue, Pacific Grove, CA 93950 T: 831.648.3183 • F: 831.648.3184 • www.ci.pg.ca.us/cdd

ARCHITECTURAL PERMIT

&

TREE PERMIT WITH DEVELOPMENT

#17-507

FOR A PROPERTY LOCATED AT 1149 FOREST AVENUE TO ALLOW EXTERIOR CHANGES, INCLUDING A TWO-STORY ADDITION OF 1,540 GROSS SQUARE FEET AT THE CENTER OF THE PROPERTY; AND THE DEMOLITION OF A GARAGE AT THE REAR OF THE PROPERTY TO BE REPLACED WITH A TWO-STORY ADDITION OF 1,400 GROSS SQUARE FEET; AND SIDING MATERIAL AND WINDOW UPGRADES TO THE EXISTING BUILDINGS IN THE FRONT AND THE CENTER OF THE PROPERTY. THE COMPLETED PROJECT PROPOSES A TOTAL OF ELEVEN (11) PARKING SPACES, THE REMOVAL OF AN EUCALYPTUS TREE, AND A REPLANT OF ONE COAST LIVE OAK TREE ON SITE.

FACTS

- 1. The subject site is located at 1149 Forest Avenue, Pacific Grove, 93950 (APN 006-713-024)
- 2. The subject site has a designation of Commercial on the adopted City of Pacific Grove General Plan Land Use Map.
- 3. The project site is located in the C-FH (Commercial-Forest Hill) zoning district.
- 4. The subject site is an interior lot of 9,399 square feet.
- 5. The subject site is developed with a two-story mixed-use building in the front of the property (1155 Forest Avenue), and a two-story duplex in the center of the building (1145 and 1147 Forest Avenue).
- 6. The subject site is located in the Watershed Management Runoff Retention Zone 1.
- 7. The subject properties are not listed in the Historic Resources Inventory.
- 8. The subject property proposes to remove a multi-stemmed Eucalyptus tree that is greater than 12 inches in trunk diameter, which is a Protected Tree pursuant to P.G.M.C. 12.20.020.
- 9. P.G.M.C. 23.64.190 requires one and one-half parking spaces for each apartment unit have less than two bedrooms, and two spaces for all other units, and one space for each unit shall be in a garage or carport; and not less than one parking space for each 300 square feet of floor area of each professional office building permitted.
- 10. This project has been determined to be CEQA Exempt under CEQA Guidelines 15301(e)(2), Existing Facilities.

FINDINGS

- 1. The proposed development will meet the development regulations set forth in the C-FH zoning district including setbacks and height requirements and;
- 2. The architecture and general appearance of the completed project is compatible with the neighborhood because the proposed exterior will be compatible with the size, scale and proportions of the existing structure and other structures in the neighborhood, in that the proposal is consistent with Architectural Review Guidelines No. 28, 31, and 36 and:
- 3. The completed project will neither be detrimental to the orderly and harmonious development of the city nor impair the desirability of investment or occupation in the neighborhood because the project will be improving the subject property, and;
- 4. The Staff have been guided by and made reference to applicable provisions of the Architectural Review Guidelines in making its determinations on the structures, and;
- 5. The proposed completed project will have a total of 11 parking spaces, of which 6 are covered and 5 are uncovered, and one of the uncovered spaces shall be a Shared Parking Space between the commercial and residential uses, satisfying the requirement of P.G.M.C. 23.64.190, and;

- 6. The proposed project furthers the General Plan Housing Element's Goal #2 and #3.
- 7. A Tree Resource Assessment was completed by Frank Ono, ISA Certified Arborist #536, and recommended a tree replant of a Coast Live Oak to replace the Eucalyptus tree if removed.

PERMIT

Architectural permit (AP) #17-507 for a property located at 1149 Forest Avenue to allow exterior changes, including a two-story addition of 1,540 gross square feet in the center of the property; and the demolition of a garage at the rear of the property to be replaced with a two-story addition of 1,400 gross square feet; and siding material and window upgrades to the existing buildings in the front and the center of the property. The completed project proposes a total of eleven (11) parking spaces, the removal of an Eucalyptus tree, and a replant of one Coast Live Oak tree on site.

CONDITIONS OF APPROVAL

- 1. **Permit Expiration.** This permit shall expire and be null and void if a building permit has not been applied for within one (1) year from and after the date of approval. Application for extension of this approval must be made prior to the expiration date.
- 2. Construction Compliance. All construction must occur in strict compliance with the proposal as set forth in the application, subject to any special conditions of approval herein. Any deviation from approvals must be reviewed and approved by staff, and may require Architectural Review Board approval.
- 3. **Terms and Conditions**. These terms and conditions shall run with the land, and it is the intention of the CDD Director and the Permittee to bind all future owners and possessors of the subject property to the terms and conditions, unless amended. Amendments to this permit may be achieved only if an application is made and approved, pursuant to the Zoning Code.
- 4. **Public Works, Fire and Building.** Review and approval by the Public Works, Fire and Building Departments are required prior to issuance of a building permit. Work taking place in the public right-of-way shall require an encroachment permit prior to issuance of the building permit.
- 5. **Conformance to Plans.** Development of the site shall conform to approved plans for "Residential Remodel, on file with the Community Development Department and to the Building Code, with the exception of any subsequently approved changes.
- 6. **Tree Protection Standards During Construction**: Pursuant to Municipal Code Chapters 12.20 and 12.30, and the *Urban Forestry Standards*, all trees that are otherwise protected and will be impacted as a result of Development, both proposed for pruning or removal and where the development will impact the critical root zone of the tree are protected. Prior to issuance of the building permit, the Project Arborist shall review grading, drainage, utility, building and landscape plans to determine impacts to individual Trees, to determine required minimum Tree protection standards during construction.

7. Tree Best Management Practices:

- a. Tree service contractors will verify animal or bird nesting prior to tree work. If nesting activity of migratory birds are found, work must stop and a wildlife biologist consulted before commencing work (the typical bird nesting season ranges from February 22 to August 1).
- b. Do not deposit any fill around trees, which may compact soils and alter water and air relationships. Avoid depositing fill, parking equipment, or staging construction materials near existing trees. Covering and compacting soil around trees can alter water and air relationships with the roots. Fill placed within the drip line may encourage the development of oak root fungus (Armillaria mellea). As necessary, trees may be protected by boards, fencing or other materials to delineate protection zones.

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- c. Pruning shall be conducted so as not to unnecessarily injure the tree. General-Principals of pruning include placing cuts immediately beyond the branch collar, making clean cuts by scoring the underside of the branch first, and for live oak, avoiding the period from February through May.
- d. Native live trees are not adapted to summer watering and may develop crown or root rot as a result. Do not regularly irrigate within the drip line of oaks. Native, locally adapted, drought resistant species are the most compatible with this goal.
- e. Root cutting should occur outside of the springtime. Late June and July would likely be the best. Pruning of the live crown should not occur February through May.
- f. Tree material greater than 3 inches in diameter remaining on site more than one month that is not cut and split into firewood must be covered with thick clear plastic that is dug in securely around the pile to discourage infestation and dispersion of bark beetles.
- g. A mulch layer up to approximately 4 inches deep should be applied to the ground under selected trees following construction. Only 1 to 2 inches of mulch should be applied within 1 to 2 feet of the trunk, and under no circumstances should any soil or mulch be placed against the root crown (base) of trees. The best source of mulch 1149 Forest Avenue Tree Assessment July 18, 2017 Not an Official City Document would be from chipped material generated on site.
- h. If trees along near the development are visibly declining in vigor, a Professional Forester or Certified Arborist should be contacted to inspect the site to recommend a course of action.
- 8. **Tree Replant:** A tree replant of a Coast Live Oak, or similar to be approved by the City Arborist, shall be required prior to completion of building permit.
- 9. **Lighting**: All exterior lighting must conform to Architectural Review Guidelines Nos. 10,11,12
- 10. **Story Poles and Netting**: Following the 10 day appeal period all story poles and netting are required to be removed.
- 11. **Building Plans:** All conditions of approval for the Planning permit(s) shall be printed on a full size sheet and included with the construction plan set submitted to the Building Department.
- 12. **Parking:** One space shall be shared parking, with a sign that shall state "No parking between 6pm-7am, except for residents," or similar, to be approved by the Architecture Review Board or Community & Economic Development Department.

NOW, THEREFORE, BE IT RESOLVED BY THE ARCHITECTURAL REVIEW BOARD OF THE CITY OF PACIFIC GROVE:

- 1. The Board determines that each of the Findings set forth above is true and correct, and by this reference incorporates those Findings as an integral part of this Permit.
- 2. The Board authorizes Approval of AP 17-507 to allow exterior changes, including a two-story addition of 1,540 gross square feet in the center of the property; and the demolition of a garage at the rear of the property to be replaced with a two-story addition of 1,400 gross square feet; and siding material and window upgrades to the existing buildings in the front and the center of the property. The completed project proposes a total of eleven (11) parking spaces, the removal of an Eucalyptus tree, and a replant of one Coast Live Oak tree on site.
- 3. This permit shall become effective upon the expiration of the 10-day appeal period.
- 4. This permit shall not take effect until the owner acknowledges and agrees to all terms and conditions and agrees to conform to and comply with those terms and conditions.

Page 3 of 4 Permit No. AP 17-507

		Item 8a
	ted at a regular meeting of by the following vote:	the Architectural Review Board of the City of Pacific Grove on the 8 th day
AYES:	XXX	
NOES:	XXX	
ABSENT:	XXX	
APF	ROVED:	
		Rick Steres, Chair
The undersigned her comply with, said ter	•	e to the approved terms and conditions, and agree to fully conform to, and

Date

Mark Abrahams, of KA Residential LLC, Property Owner

Page 4 of 4 Permit No. AP 17-507

Tree Resource Assessment 1149 Forest Avenue Pacific Grove, CA

Prepared for:

KA Residential

Prepared by:

Frank Ono
Urban Forester
Member Society of American Foresters #48004
ISA Certified Arborist #536
1213 Miles Avenue
Pacific Grove, CA 93950

Owner's Representative:

KA Residential Mr. Mark Abrahams 50 Woodside Plaza #313 Redwood City, CA 940651

Architect:

Gather Management, LLC 4405 Brookshire Circle Santa Rosa, CA 95405

Forester and Arborist

Frank Ono, Member SAF #48004, ISA Certified Arborist #536 F.O. Consulting 1213 Miles Ave Pacific Grove, CA 93950

SUMMARY

Development is proposed for this site consisting of a remodel and addition to existing structures. There are two trees (Oak and Eucalyptus) on the property which are protected by Pacific Grove City Ordinances. Excavation and hardscape removal will be performed requiring removal of the Eucalyptus tree. A tree assessment/arborist report has been prepared that identifies and addresses the affects that the project will have to the existing tree resources on site as well as a list of recommendations regarding trees on the project.

INTRODUCTION

This tree assessment/arborist report is prepared for KA Residential, the owner's representative for the property located at 1149 Forest Avenue (formerly 1145, 1147, and 1155 Forest Avenue) by Frank Ono, Urban Forester and Certified Arborist (member Society of American Foresters #48004 and International Society of Arboriculture Certified Arborist #536) due to the proposed construction. Mr. Abrahams was notified by the City of Pacific Grove that it's Land Use Plan and City Zoning Ordinances identify trees greater than 12" in diameter as species requiring protection and special consideration for management.

ASSIGNMENT/SCOPE OF PROJECT

To ensure protection of the tree resources on site, I have been requested for an assessment of the trees in proximity to proposed development areas. The findings of the report are to be documented in an arborist report to work in conjunction with other conditions for approval of the building permit application. To accomplish this assignment, the following tasks have been completed;

- Evaluate health, structure and preservation suitability for each tree within or adjacent (15 feet or less) to proposed development of trees greater than or equal to 12 diameter inches at 54 inches above grade.
- Review proposed building site plans as provided by KA Residential, Mr. Mark Abrahams.
- Make recommendations for alternative methods and preconstruction treatments to facilitate tree retention.
- Create preservation specifications, as it relates to a Tree Location/Preservation Map.
- Determine the quantity of trees affected by construction as defined by the City of Pacific Grove Zoning Ordinance; as well as mitigation requirements for those to be affected.
- Document findings in the form of a report as required by the City of Pacific Grove Planning Department.

LIMITATIONS

This assignment is limited to the review of plans submitted to me July 17, 2017 drawn by Gather Management LLC for KA Residential to assess affects from potential construction to trees within or adjacent to construction activities. The assessment has been made of these plans specifically and no other plans were reviewed. Only minor grading and erosion details are discussed in this report as it relates to tree health. It is not the intent of this report to be a monetary valuation of the trees or provide risk assessment for any tree on this parcel, as any tree can fail at any time. No clinical diagnosis was performed on any pest or pathogen that may or may not be present. In addition to an inspection of the property, F.O. Consulting relied on information provided in the preparation of this report (such as, surveys, property boundaries, and property ownership) and must reasonably rely on the accuracy of the information provided. F.O. Consulting shall not be responsible for another's means, methods, techniques, schedules, sequence or' procedures, or for contractor safety or any other related programs; or for another's failure to complete the work in accordance with the plans and specifications.

PURPOSE AND GOAL

This Tree Assessment/Arborist report is prepared for this parcel due to proposed construction activities located at 1149 Forest Avenue, Pacific Grove, CA. The purpose of the assessment is to determine what, if any, of the trees will be affected by the proposed project. Trees greater than 12" in diameter are considered protected trees as defined by the City of Pacific Grove Zoning Ordinances.

The goal of this report is to protect and maintain the Pacific Grove Urban forested resources through the adherence of development standards, which allow the protection, and maintenance of its forest resources. Furthermore it is the intended goal of this report to aid in planning to offset any potential effects of proposed development on the property while encouraging forest stability and sustainability, perpetuating the forested character of the property and the immediate vicinity.

SITE DESCRIPTION

- 1) Assessor's Parcel Number: 006-713-024-000.
- 2) Location: 1149 Forest Avenue, Pacific Grove CA.
- 3) Parcel size: .2 Acres.
- 4) Existing Land Use: The parcel is zoned Commercial/Residential mixed use.
- 5) Slope: The parcel ranges from mild to steeper sloped. Slopes are less than 25%.
- 6) Soils: The parcel is located on soils classified by the Monterey County Soils report as Sheridan and Narlon soils. Sheridan are a moderately sloping to strongly sloping soil on the lower side slopes of granitic uplands or on small rounded ridgetops. Runoff is medium, and the erosion hazard is slight. Narlon soils are a gently sloping and moderately sloping soil on dissected marine terraces with a profile described as representative of the series. The clay subsoil is at a depth of 15 to 20 inches. Slopes are mostly 3 to 6 percent. Runoff is slow to medium, and temporary shallow ponds form in swales in wet winters. The erosion hazard is moderate. The seedling mortality is low, and the wind throw hazard is severe.
- 7) Vegetation: The vegetation on site is composed primarily of an Oak and ornamental planting.
- 8) Forest Condition and Health: The stand of trees and health are evaluated with the use of the residual trees combined with surrounding adjacent trees as a complete stand. The site is developed and surrounding forest canopy is fragmented. It is a remnant of a former closed cone forest with considerable upper pine forest dying off due to disease and urbanization.

BACKGROUND

Assessment focuses on incorporation of the preliminary location of site improvements coupled with consideration for the general goals of site improvement desired of the landowner. Proposed improvements assessed included preserving trees to the greatest extent feasible, maintaining the view shed and general aesthetic quality of the area while complying with City of Pacific Grove Municipal Codes. The study of individual trees determined treatments necessary to complete the project and meet the goals of the landowner. Trees within and immediately adjacent proposed development area were located, measured, inspected, flagged and recorded. The assessment of each tree concludes with an opinion of whether the tree should be removed, or preserved, based on the extent and effect of construction activity to the short and long-term health of the tree. All meetings and field review were focused on the area immediately surrounding the proposed development.

OBSERVATIONS/DISCUSSION

The following list includes observations made while on site, and summarizes details discussed during this stage of the planning process.

- The site is developed with an existing structure and hardscaped parking area. My
 understanding is that with the Oak is to be retained and the Eucalyptus will be
 removed.
- There is one Coast live oak (#133) on the property which will be retained. Upon close inspection it appears construction is at a distance that encroachment, if at all, would be minimal and due to the soil type not many roots will be encountered. The tree is expected to satisfactorily survive construction provided work near the tree is monitored and the tree protected.
- The Eucalyptus (#134) is a multiple stemmed tree Stringy bark silver dollar eucalyptus tree (*Eucalyptus cinerea*). The tree has lifted in the soil and has several stems which are weakly attached and leaning toward other properties and buildings. The rooting of the tree is shallow and will be impacted by grading.

CONCLUSION/PROJECT ASSESSMENT

This proposal to remodel and add on to existing structures requires removal of the Eucalyptus tree. The other remaining Oak on the property will remain and protected from construction impacts.

No significant long term affects to the urban forest ecosystem is anticipated as this is already a developed commercial/residential site and planting to be removed is ornamental. The project as proposed is not likely to significantly reduce the availability of wildlife habitat over the long term. Whenever construction activities take place near trees, there is the potential for those trees to experience decline in the long term as well. The greatest attempt has been made to identify for removal those trees likely to experience decline.

RECOMMENDATIONS

Tree Removal

The City of Pacific Grove through Its General Plan and City Ordinances has tree replacement conditions as part of a tree removal permit when sufficient space exists to replant that does not create an overcrowded vegetated situation. The City typically requires a replacement for removed trees which is at the discretion of the City. It is recommended that if a tree replacement is required it be with Coast live oak at a ratio recommended by the City arborist.

Tree Protection

There is an oak that is to be retained. Prior to the commencement of construction activities the following best management practices shall be implemented:

Best Management Practices to Observe (BMP)

The following best management practices must be adhered to:

- A) Tree service contractors will verify animal or bird nesting prior to tree work. If nesting activity of migratory birds are found, work must stop and a wildlife biologist consulted before commencing work (the typical bird nesting season ranges from February 22 to August 1).
- B) Do not deposit any fill around trees, which may compact soils and alter water and air relationships. Avoid depositing fill, parking equipment, or staging construction materials near existing trees. Covering and compacting soil around trees can alter water and air relationships with the roots. Fill placed within the drip line may encourage the development of oak root fungus (Armillaria mellea). As necessary, trees may be protected by boards, fencing or other materials to delineate protection zones.
- C) Pruning shall be conducted so as not to unnecessarily injure the tree. General-Principals of pruning include placing cuts immediately beyond the branch collar, making clean cuts by scoring the underside of the branch first, and for live oak, avoiding the period from February through May.
- D) Native live trees are not adapted to summer watering and may develop crown or root rot as a result. Do not regularly irrigate within the drip line of oaks. Native, locally adapted, drought resistant species are the most compatible with this goal.
- E) Root cutting should occur outside of the springtime. Late June and July would likely be the best. Pruning of the live crown should not occur February through May.
- F) Tree material greater than 3 inches in diameter remaining on site more than one month that is not cut and split into firewood must be covered with thick clear plastic that is dug in securely around the pile to discourage infestation and dispersion of bark beetles.
- G) A mulch layer up to approximately 4 inches deep should be applied to the ground under selected trees following construction. Only 1 to 2 inches of mulch should be applied within 1 to 2 feet of the trunk, and under no circumstances should any soil or mulch be placed against the root crown (base) of trees. The best source of mulch

would be from chipped material generated on site.

H) If trees along near the development are visibly declining in vigor, a Professional Forester or Certified Arborist should be contacted to inspect the site to recommend a course of action.

Report Prepared By:

July 18, 2017

Frank Ono, SAF Forester #48004 and ISA Certified Arborist #536

Date

PHOTOGRAPHS



Tree #133



Tree #134



Tree #134



Base of tree #134


RESIDENTIAL

DRAWING

AZA #313 SA 94061

SO WO REDWC MARK TEL: EMAIL:

RESIDENTIAL REMODEL AND ADDITION 1149 FOREST AVE (1145, 1147 & 1155 FOREST AVE) PACIFIC GROVE, CA 93950

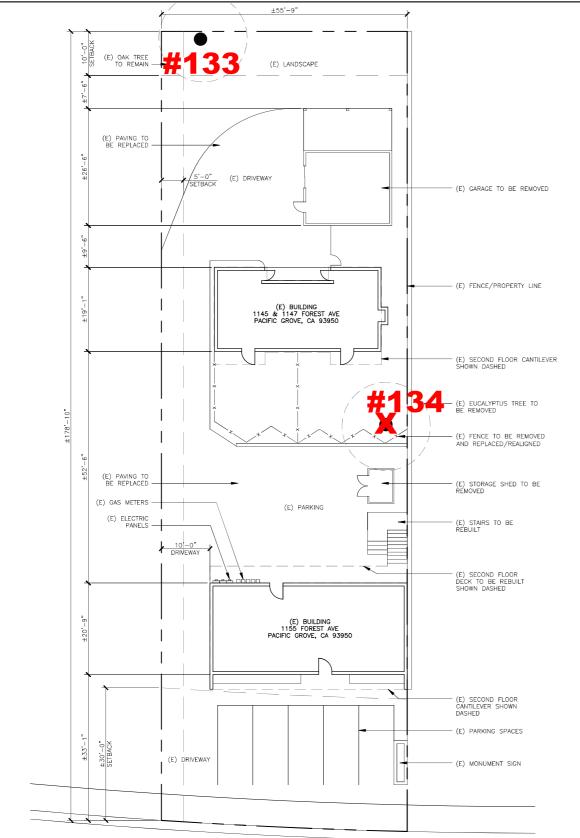

FOREST AVENUE

PROJECT DATA SHEET

PROJECT DATA SHEET

Project Address: 1149 FOREST AVENUE Submittal Date: 07/12/2017 Permit Type(s) & No(s): MARK ABRAHAMS

	REQUIRED/ Permitted	Existing Condition	Proposed Condition	Notes
Zone District		C-FH	C-FH	
Building Site Area		±9,399	±9,399	
Density (multi-family projects only)	30/ACRE	4 UNITS	6 UNITS	
Building Coverage		24%	34%	INCLUDES COVERED STAIR
Site Coverage	75%	72%	71%	
Gross Floor Area		±3,971	±6,381	INCLUDES GARAGES
Square Footage not counted towards Gross Floor Area		N/A	400	COVERED STAIR STRUCTURE
mpervious Surface Area Created and/or Replaced		±6,765	±6,129	TURF-BLOCK PAVING
Exterior Lateral Wall Length to be demolished in feet & % of total*			93 _{ft/27} %	
Exterior Lateral Wall Length to be built			230'	
Building Height	35'	±22'	±22'	
Number of stories	2	2	2	
Front Setback	0'	30'	30'	
Side Setback (specify side)	0,	0,	0'	
Side Setback (specify side)	5'	10'	10'	
Rear Setback	10'	18'	10"	
Garage Door Setback		140'	140'	
Covered Parking Spaces		2	6	
Uncovered Parking Spaces		8	5	
Parking Space Size (Interior measurement)	9° x 20°	9'x20'	9'x20'	
Number of Driveways	1	1	1	
Driveway Width(s)		10'	10'	
Back-up Distance		25"	25'	
Eave Projection (Into Setback)	3' maximum	N/A	N/A	
Distances Between Eaves & Property Lines	3' minimum	N/A	N/A	
Open Porch/Deck Projections		3'-10"	3'-10"	
Architectural Feature Projections		N/A	N/A	
Number & Category of Accessory Buildings		N/A	N/A	N/A
Accessory Building Setbacks		N/A	N/A	N/A
Distance between Buildings		9'-6"	4'-0"	
Accessory Building Heights		N/A	N/A	N/A
Fence Heights		6'	6'	

*If project proposes demolition to an HRI structure, also indicate % of proposed demolition of the surface of all exterior walls facing a public street or streets, if applicable.

[Rev. 01/14/14]

CONTACT

OWNERS REPRESENTATIVE:

KA RESIDENTIAL, LLC.
50 WOODSIDE PLAZA #313
REDWOOD CITY, CA 94061
CONTACT: MARK ABRAHAMS
TEL: 707.815.9324
EMAIL: MABRAHAMS@KARESIDENTIAL.COM

DRAWN BY:

GATHER MANAGEMENT, LLC.
4405 BROOKSHIRE CIRCLE
SANTA ROSA, CA 95405
CONTACT: ERNEST WUETHRICH
TEL: 707.494.8857
EMAIL: ERNEST@WEAREGATHER.COM

SHEET INDEX

1145, 1147 & 1155 FOREST AVENUE

NEW BUILDING 1
A5 PROPOSED ADDITION PLAN
A6 PROPOSED ADDITION ELEVATIONS

A8 PROPOSED ADDITION ELEVATIONS

SCOPE OF WORK

REPLACE EXISTING PAVING NEW TURF-BLOCK PAVERS

1145 & 1147 FOREST AVENUE:

- REPLACE EXISTING WINDOWS REPLACE EXISTING PLUMBING FIXTURES REPLACE EXISTING ELECTRICAL NEW WASHER/DRYER REALIGN BACKYARD FENCE LINES

1155 FOREST AVENUE:

NEW BUILDING 1:

NEW BUILDING 2:

PROJECT INFORMATION

PROJECT LOCATION: 1149 FOREST AVE PACIFIC GROVE, CA 93950 PROPERTY USED FOR TWO BUILDINGS - 1145/1147 FOREST AVE & 1155 FOREST AVE

ASSESSOR'S PARCEL NUMBER: 006713024000

ZONING: C-FH FOREST HILL COMMERCIAL

VB, 2 STORY STRUCTURES CONSTRUCTION:

PROJECT DESCRIPTION: RESIDENTIAL REMODEL AND APARTMENT ADDITIONS

1145 & 1147 FOREST AVE

1155 FOREST AVE EXISTING STRUCTURE EXISTING GARAGE: +530 S.F.

PROPOSED BUILDING 1 PROPOSED BUILDING 1
PROPOSED LOWER GARAGE: 770 S.F.
PROPOSED UPPER APARTMENT: 770 S.F.
TOTAL BUILDING 1: 1,540 S.F.

PROPOSED BUILDING 2
PROPOSED LOWER GARAGE: 700 S.F.
PROPOSED UPPER APARTMENT: 700 S.F.
TOTAL BUILDING 2: 1,400 S.F.

VICINITY MAP





NORTH

RESIDENTIAL RI 1145, 1147 & 1155 FC PACIFIC GROVE, 0 SHEET NUMBER

REMODEL FOREST AVE E, CA 93950

Cover Sheet

(01) EXISTING SITE PLAN





SHE/Address: 1149 FOREST AVE	HAZARD RATING:
Map/Location: DUTH SIDE OF NY7-1155 ARVELLING	2+3+4=9
Owner: public private unknown other	Failure + Size + Target = Hazard Potential of part Rating Rating
Date: 7/18/17 Inspector: 020	Immediate action needed
Date of last inspection:	Needs further inspection
TREE CHARACTERISTICS	Dead tree
2.1	
08H: 4 of trunks: 4 Height: 50 Spread: 40	
Form:	Stag-headed
Crown class: ☐ dominant ☐ co-dominant ☐ intermediate ☐ suppressed	
Live crown ratio: 45 % Age class: Dyoung Demi-mature Dove	r-mature/senescent
Pruning history: ☐ crown cleaned ☐ excessively thinned ☐ topped ☐ crown raised ☐ pollarded ☐ none ☐ multiple pruning events Approx. dates:	
Special Value: ☐ specimen ☐ heritage/historic ☐ wildlife ☐ unusual ☐ street tree ☐ screen	
TREE HEALTH	
	h obstructions:
Foliage density: Inormal I sparse Leaf size: Inormal I small I stat	kes □wire/ties □ signs □ cables
Annual shoot growth: ☐ excellent ☐ average ☐ poor Twig Dieback? Y	b/pavement 🗆 guards
Woundwood development: ☐ excellent ☐ average ☐ poor ☐ none ☐ oth	ег
Vigor class: ☐ excellent ☐ average ☐ fair ☐ poor	
Major pests/diseases:	
SITE CONDITIONS	
Site Character: Presidence commercial industrial park open space na	
Site Character: ☐ residence ☐ commercial ☐ industrial ☐ park ☐ open space ☐ na	itural 🔲 woodland\forest
Landscape type:	
Landscape type:	border
Landscape type:	border wind break line clearing site clearing ement litted? Y N small volume disease center history of fail
Landscape type:	border
Landscape type:	border wind break line clearing site clearing ement litted? Y N small volume disease center history of fail d utilities traffic adjacent veg.
Landscape type:	border wind break line clearing site clearing ement litted? Y N small volume disease center history of fail d utilities traffic adjacent veg.
Landscape type:	border wind break line clearing site clearing ement litted? Y small volume disease center history of fail d utilities traffic adjacent veg. dward, canopy edge area prone to windthrow dom regularly
Landscape type:	border wind break line clearing site clearing ement litted? Y small volume disease center history of fail d utilities traffic adjacent veg. dward, canopy edge area prone to windthrow dom regularly


The International Society of Arboriculture assumes no responsibility for conclusions or recommendations derived from use of this form.

#_/34


TREE DEFECTS						
ROOT DEFECTS:						
Suspect root rot: Y/N Mushroom/conk/bracket present: Y/N ID:						
Exposed roots: severe	⊋moderate ⊡low Un	dermined: 🗆 severe 🗆	moderate Dlow			
Root pruned: 20 distar	nce from trunk Root area aff	ecled:% Buti	ress wounded: Y N Wh	en:		
	ere moderate I low		severe Imoderate 🗆	low		
	ertical Inatural unnatur			· · ·		
LEANY O Dueg. Holli ve	ancai Denaturai 🗆 uninatur	al ∟sen-corrected sc	oil heaving Y N			
	Roots broken Y N			- The second sec		
Compounding factors: Will	HIPLE STEM	WIENDS	Lean severity: Lisever	e Danoderate Dlow		
	V esence of individual defects and n		10 A.K. (3)			
				T		
*DEFECT	ROOT CROWN	TRUNK	SCAFFOLDS	BRANCHES		
Poor taper						
Bow, sweep						
Codominants/forks						
Multiple attachments						
Included bark						
Excessive end weight						
Cracks/splits						
Hangers						
Girdling						
Wounds/seam						
Decay						
Cavity						
Conks/mushrooms/bracket						
Bleeding/sap flow	•					
Loose/cracked bark						
Nesting hole/bee hive						
Deadwood/stubs						
Borers/termites/ants						
Cankers/galls/burls				1		
Previous failure						
HAZARD RATING						
	LOUTS					
Tree part most likely to fail:				- medium; 3 - high; 4 - severe		
Inspection period:	annual biannual	other	Size of part: 1 - <6" (15 cm	73		
Failure Potential + Size of Part +	Target Rating = Hazard Rating			-75 cm); 4 - >30" (75 cm)		
2 + 3 +	11 = 9		Target rating: 1 - occasiona	_		
3 - frequent use; 4 - constant use						
HAZARD ABATEMENT /						
Prune:	part reduce end weight o	crown clean I⊒thin I⊒rais	e canopy	∐restructure ∐shape		
Cable/Brace:		In:	spect further: 🗀 root crown	☐ decay ☐ aerial ☐ monitor		
Remove tree	lace? Y Move target;	(N) Other:				
Effect on adjacent trees: Unone 13 evaluate						
Notification: Owner	anager	Date: ///9	117	- 3		
COMMENTS						

Grids

Express your creativity and dramatically increase your home's curb appeal with our virtually endless grid options. They are placed inside the glass unit for easy cleaning.

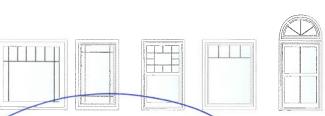



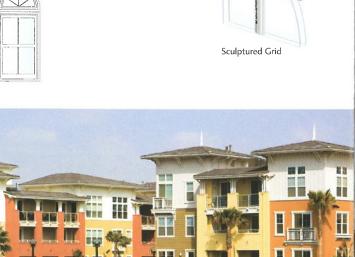

Premium Exterior Vinyl Finishes

Style Line Series gives you design flexibility with eight premium and two standard exterior colors.







Review from milgard.com -

The product line is beautiful, with slim frames and smooth mechanisms. They NOTHING when cars pass by. The sound insulation quality has exceeded expectations. I have casement and horizontal sliders and they both operate effortlessly. The overall design of this product is brilliant, tight, smart, elegant and designed for a very fussy buyer/homeowner.

Decorative Glass

Decorative glass can add privacy or design to any room. The decorative glass of your choice can be tempered, which turns it into safety glass for applications such as a shower or over a bathtub. Decorative glass is available in these and many more styles and tints.













Positive Action Lock


With its simple operation, the Milgard Positive Action Lock is window hardware you can count on to perform. Made to close and lock the window securely in one action, it eliminates any guessing. If the window is closed, it's locked. Plus, it meets and exceeds the toughest residential forced entry codes in the nation, making your windows beautiful and safer.

Casement and Awning Hardware

The operating hardware for casement and awning styles is an innovative folding handle that tucks out of the way with the locking hardware designed for smooth, easy-to-operate action.

Colors shown are approximate due to printing limitations.

RESIDENTIAL REMODEL AND ADDITION 1149 FOREST AVE (1145, 1147 & 1155 FOREST AVE) PACIFIC GROVE, CA 93950

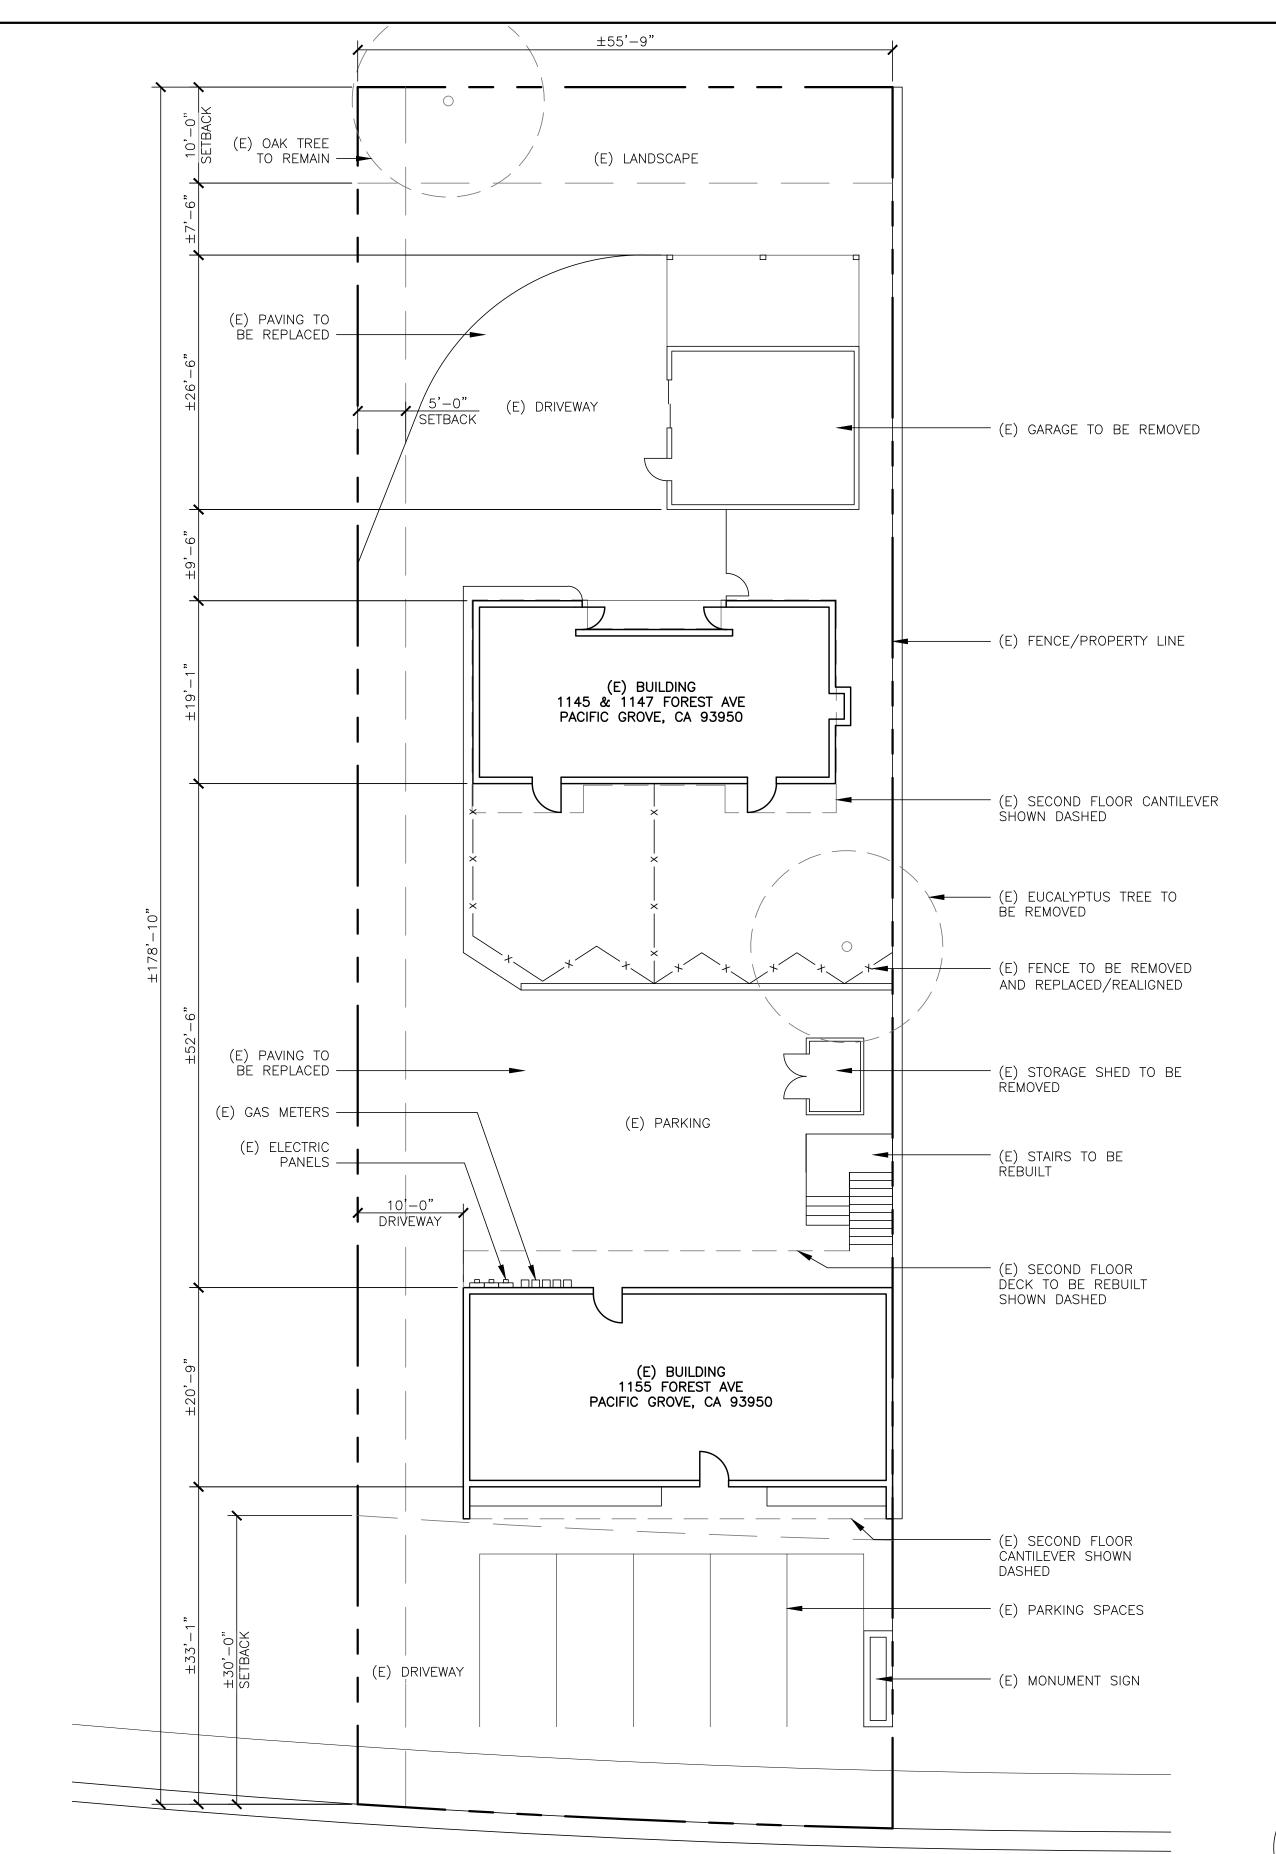



PROJECT DATA SHEET

Project Address: 1149 FOREST AVENUE **Submittal Date:** 07/12/2017

Permit Type(s) & No(s): MARK ABRAHAMS

	REQUIRED/ Permitted	Existing Condition	Proposed Condition	Notes
Zone District		C-FH	C-FH	
Building Site Area		±9,399	±9,399	
Density (multi-family projects only)	30/ACRE	4 UNITS	6 UNITS	
Building Coverage		24%	34%	INCLUDES COVERED STAIR
Site Coverage	75%	72%	71%	
Gross Floor Area		±3,971	±6,381	INCLUDES GARAGES
Square Footage not counted towards Gross Floor Area		N/A	400	COVERED STAIR STRUCTURE
Impervious Surface Area Created and/or Replaced		±6,765	±6,129	TURF-BLOCK PAVING
Exterior Lateral Wall Length to be demolished in feet & % of total*			93 _{ft} /27%	
Exterior Lateral Wall Length to be built			230'	
Building Height	35'	±22'	±22'	
Number of stories	2	2	2	
Front Setback	0'	30'	30'	
SOUTH Side Setback (specify side)	0'	0'	0'	
NORTH Side Setback (specify side)	5'	10'	10'	
Rear Setback	10'	18'	10'	
Garage Door Setback		140'	140'	
Covered Parking Spaces	6	2	6	
Uncovered Parking Spaces	6	8	5	SEE NOTE BELOW
Parking Space Size (Interior measurement)	9' x 20'	9'x20'	9'x20'	
Number of Driveways	1	1	1	
Driveway Width(s)		10'	10'	
Back-up Distance		25'	25'	
Eave Projection (Into Setback)	3' maximum	N/A	N/A	
Distances Between Eaves & Property Lines	3' minimum	N/A	N/A	
Open Porch/Deck Projections		3'-10"	3'-10"	
Architectural Feature Projections		N/A	N/A	
Number & Category of Accessory Buildings		N/A	N/A	N/A
Accessory Building Setbacks		N/A	N/A	N/A
Distance between Buildings		9'-6"	4'-0"	
Accessory Building Heights		N/A	N/A	N/A
Fence Heights		6'	6'	

*If project proposes demolition to an HRI structure, also indicate % of proposed demolition of the surface of all exterior walls facing a public street or streets, if applicable.

[Rev. 01/14/14]

ONE (1) PARKING SPACE SHALL BE SHARED PARKING, WITH A SIGN THAT WILL STATE "NO PARKING BETWEEN __PM - __AM, EXCEPT FOR RESIDENTS."

CONTACT

OWNERS REPRESENTATIVE:

KA RESIDENTIAL, LLC. 50 WOODSIDE PLAZA #313 REDWOOD CITY, CA 94061 CONTACT: MARK ABRAHAMS 707.815.9324 EMAIL: MABRAHAMS@KARESIDENTIAL.COM DRAWN BY:

GATHER MANAGEMENT, LLC. 4405 BROOKSHIRE CIRCLE SANTA ROSA, CA 95405 CONTACT: ERNEST WUETHRICH TEL: 707.494.8857

EMAIL: ERNEST@WEAREGATHER.COM

	REQUIRED/ Permitted	Existing Condition	Proposed Condition	Notes
Zone District		C-FH	C-FH	
Building Site Area		±9,399	±9,399	
Density (multi-family projects only)	30/ACRE	4 UNITS	6 UNITS	
Building Coverage		24%	34%	INCLUDES COVERED STAIR
Site Coverage	75%	72%	71%	
Gross Floor Area		±3,971	±6,381_	INCLUDES GARAGES
Square Footage not counted towards Gross Floor Area		N/A	400	COVERED STAIR STRUCTURE
Impervious Surface Area Created and/or Replaced		±6,765	±6,129	TURF-BLOCK PAVING
Exterior Lateral Wall Length to be demolished in feet & % of total*			93 _{ft} /27%	
Exterior Lateral Wall Length to be built			230'	
Building Height	35'	±22'	±22'	
Number of stories	2	2	2	
Front Setback	0'	30'	30'	
SOUTH Side Setback (specify side)	0'	0'	0'	
NORTH Side Setback (specify side)	5'	10'	10'	
Rear Setback	10'	18'	10'	
Garage Door Setback		140'	140'	
Covered Parking Spaces	6	2	6	
Uncovered Parking Spaces	6	8	5	SEE NOTE BELOW
Parking Space Size (Interior measurement)	9' x 20'	9'x20'	9'x20'	
Number of Driveways	1	1	1	
Driveway Width(s)		10'	10'	
Back-up Distance		25'	25'	
Eave Projection (Into Setback)	3' maximum	N/A	N/A	
Distances Between Eaves & Property Lines	3' minimum	N/A	N/A	
Open Porch/Deck Projections		3'-10"	3'-10"	
Architectural Feature Projections		N/A	N/A	
Number & Category of Accessory Buildings		N/A	N/A	N/A
Accessory Building Setbacks		N/A	N/A	N/A

PROJECT LOCATION:

PROPERTY USED FOR TWO BUILDINGS - 1145/1147

1149 FOREST AVE

PACIFIC GROVE, CA 93950

ASSESSOR'S PARCEL NUMBER: 006713024000

ZONING: FOREST HILL COMMERCIAL

COMMERCIAL/RESIDENTIAL USE:

MIXED USE

VB, 2 STORY STRUCTURES CONSTRUCTION:

PROJECT DESCRIPTION:

RESIDENTIAL REMODEL AND APARTMENT ADDITIONS

±9,399.41 S.F.

1145 & 1147 FOREST AVE

EXISTING STRUCTURE: ±1,417 S.F.

SHEET INDEX

SP1 PROPOSED SITE PLAN

A1 PROPOSED FLOOR PLANS A2 PROPOSED ELEVATIONS

A5 PROPOSED ADDITION PLAN A6 PROPOSED ADDITION ELEVATIONS

A8 PROPOSED ADDITION ELEVATIONS

A3 PROPOSED ELEVATIONS A4 PROPOSED ELEVATIONS

SCOPE OF WORK

4. NEW WASHER/DRYER

1155 FOREST AVENUE:

REPLACE EXISTING PAVING 2. NEW TURF-BLOCK PAVERS

1145 & 1147 FOREST AVENUE:

REPLACE EXISTING WINDOWS

3. REPLACE EXISTING ELECTRICAL

5. REALIGN BACKYARD FENCE LINES

REPLACE EXISTING ELECTRICAL 4. REPLACE EXISTING STAIRS AND DECK 5. NEW STUCCO WALL FINISH AND TRIM WORK

b. UPPER 770 S.F. APARTMENT

b. UPPER 700 S.F. APARTMENT

NEW 2 STORY STRUCTURE:

NEW 2 STORY STRUCTURE:

PROJECT INFORMATION

REPLACE EXISTING PLUMBING FIXTURES

REPLACE EXISTING PLUMBING FIXTURES

a. LOWER 3 CAR GARAGE SERVING NEW

a. LOWER 3 CAR GARAGE SERVING NEW

APARTMENT, AND 1155 FOREST AVENUE

APARTMENT, AND 1145/1147 FOREST AVENUE

SITE WORK:

1145, 1147 & 1155 FOREST AVENUE

1155 FOREST AVE

EXISTING STRUCTURE: ±2,024 S.F. ±530 S.F. EXISTING GARAGE:

PROPOSED BUILDING 1

PROPOSED LOWER GARAGE: 770 S.F. PROPOSED UPPER APARTMENT: 770 S.F.

TOTAL BUILDING 1:


PROPOSED BUILDING 2

PROPOSED LOWER GARAGE: 700 S.F. PROPOSED UPPER APARTMENT: 700 S.F. TOTAL BUILDING 2:

VICINITY MAP

SITE AREA:



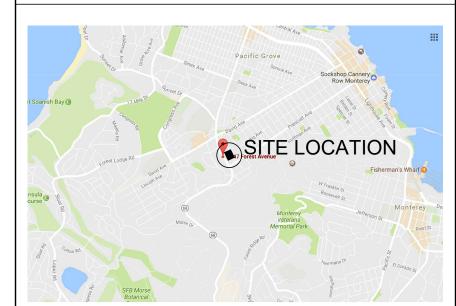

SCALE: 1"=10'-0"

NORTH

FOREST AVENUE O1) EXISTING SITE PLAN
SCALE: 1"=10'-0"

0' 5' 10'




SIDENTIAL

XES 149

SHEET NUMBER

元 /

Cover Sheet

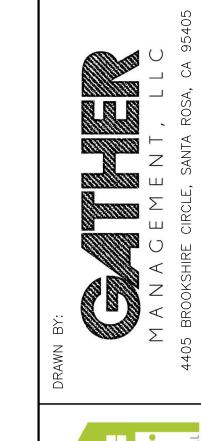



CLIENT:

KA RESIDENTIAL, LLC

50 WOODSIDE PLAZA #313
REDWOOD CITY, CA 94061
MARK ABRAHAMS
TEL: 707.815.9324
EMAIL: MABRAHAMS@KARESIDENTIAL.COM


DRAWING ISSUED FOR PLANNING

| 07/13/17 | ISSUED FOR PLANNING

RESIDENTIAL REMODEL 1145, 1147 & 1155 FOREST AVE PACIFIC GROVE, CA 93950


SHEET NUMBER


SP1
Site Plan

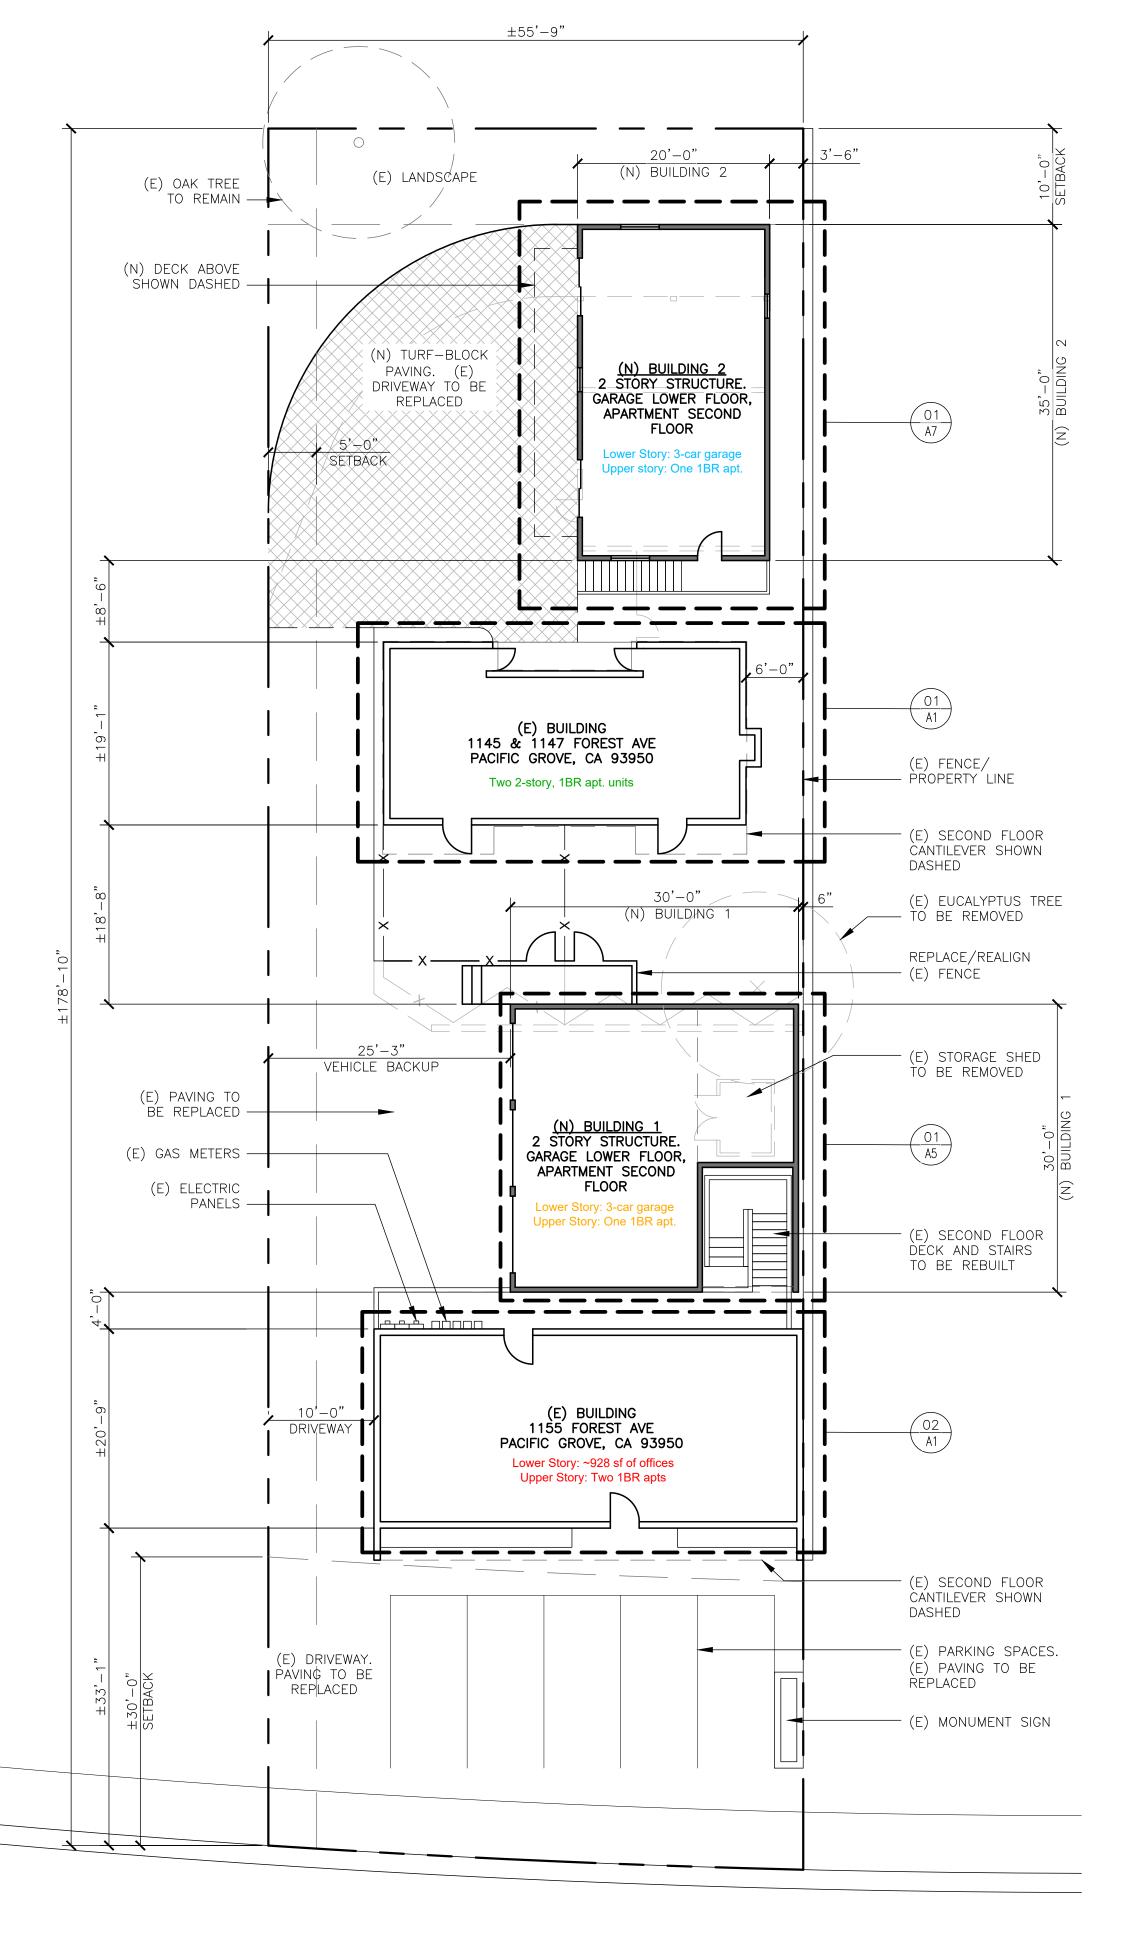


FOREST AVENUE



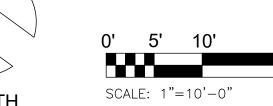

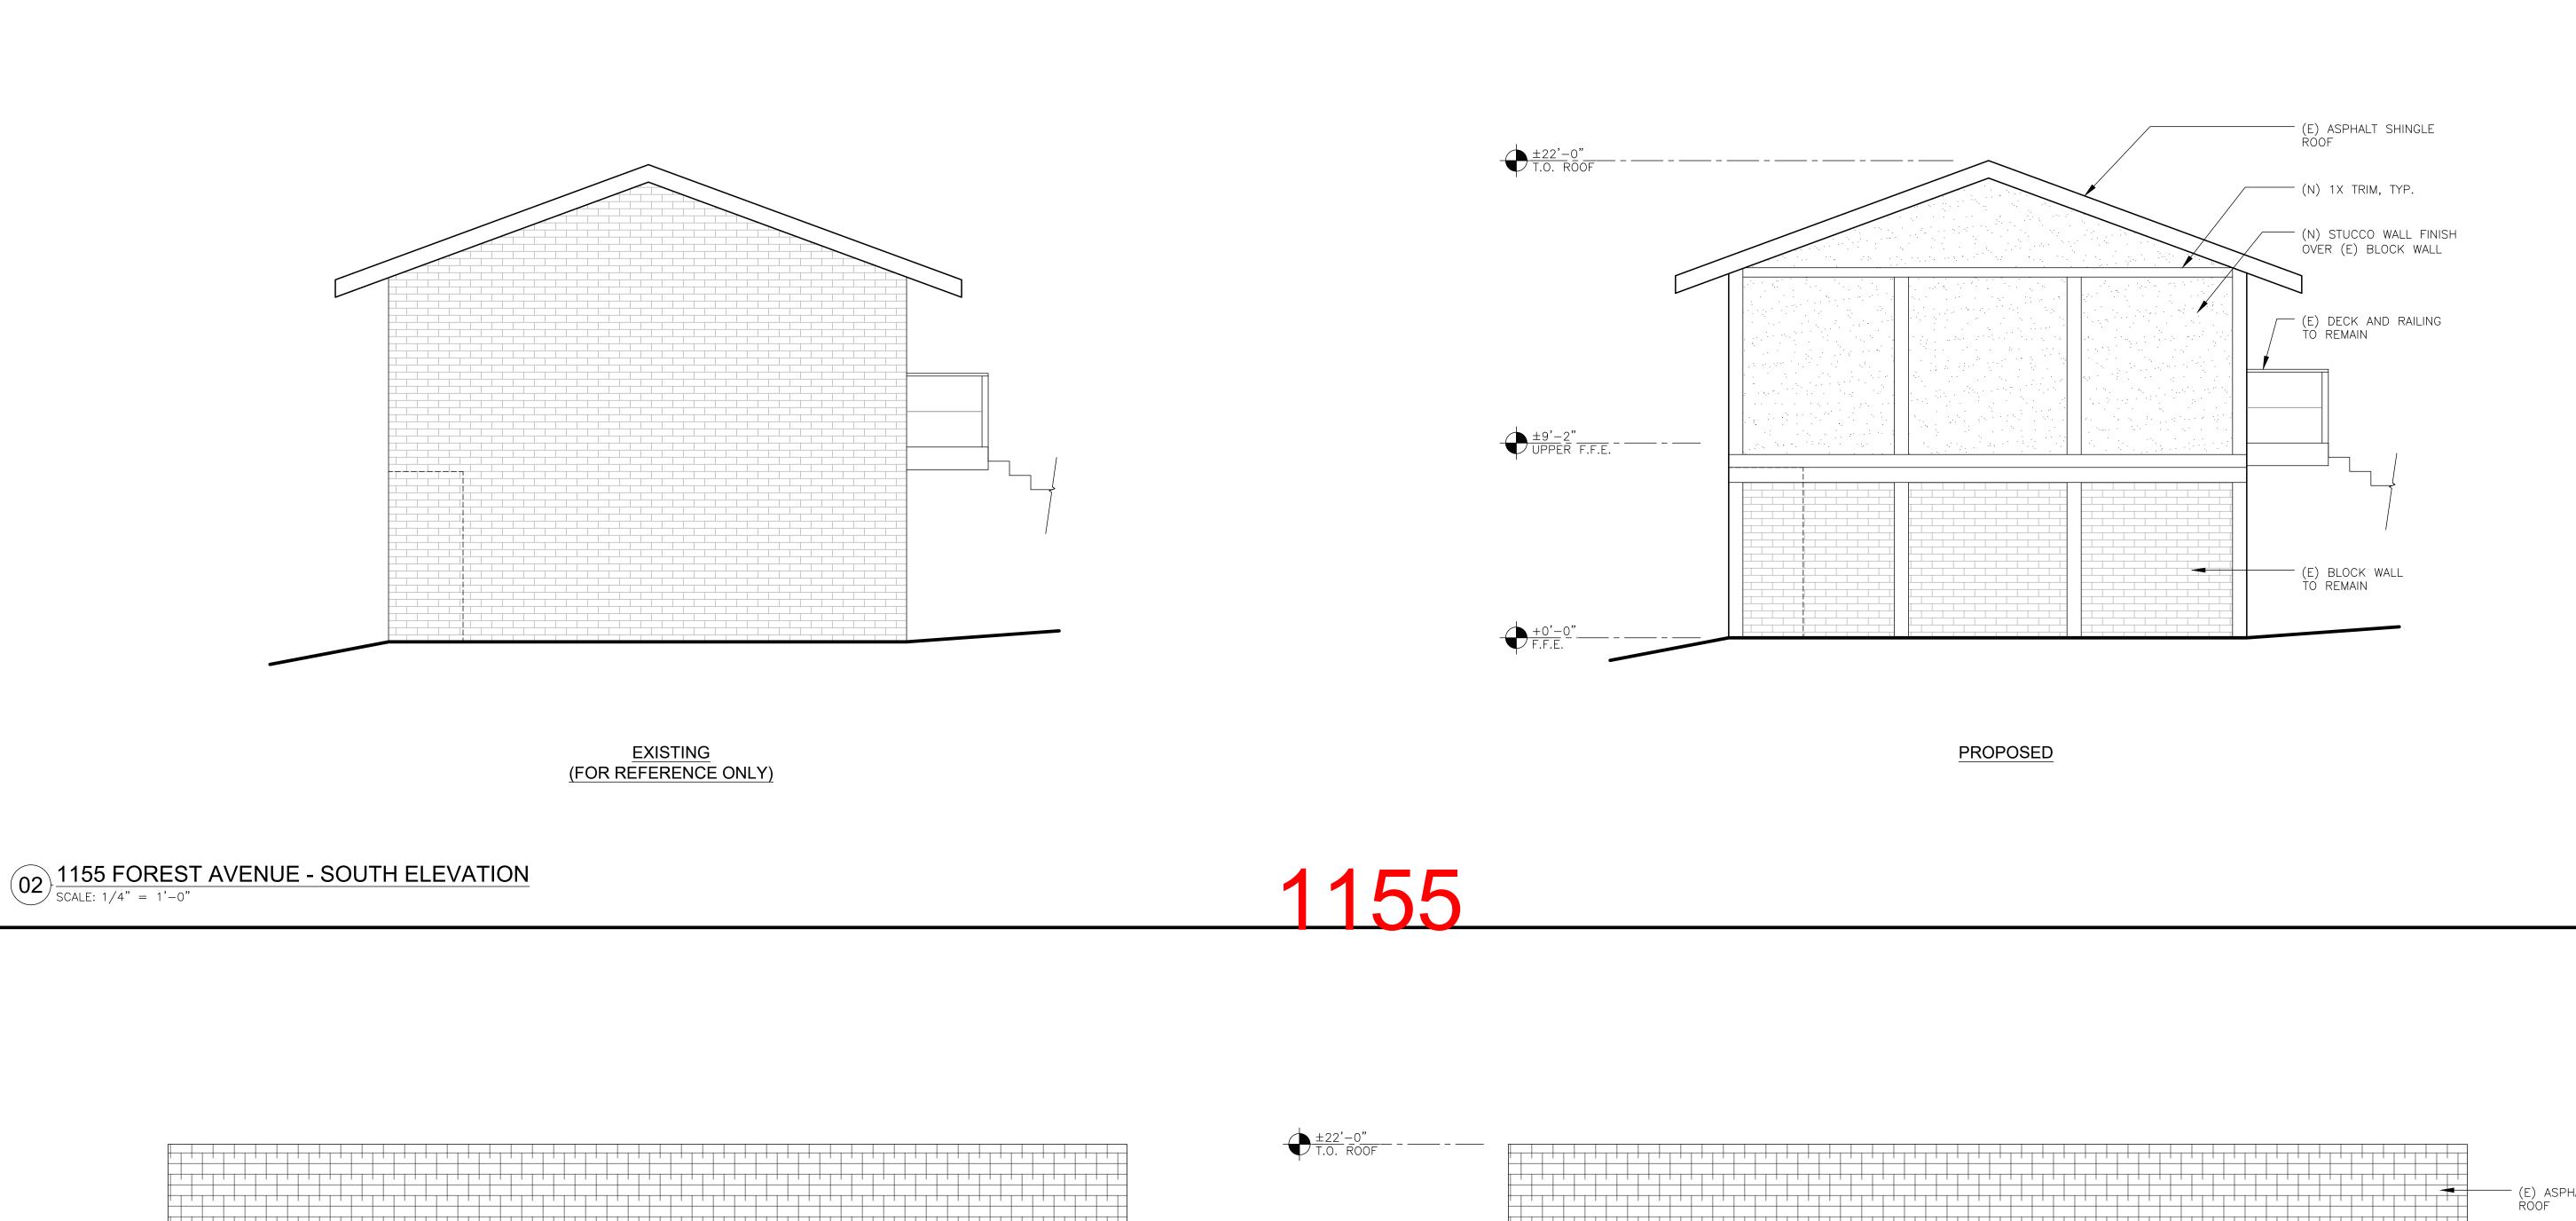

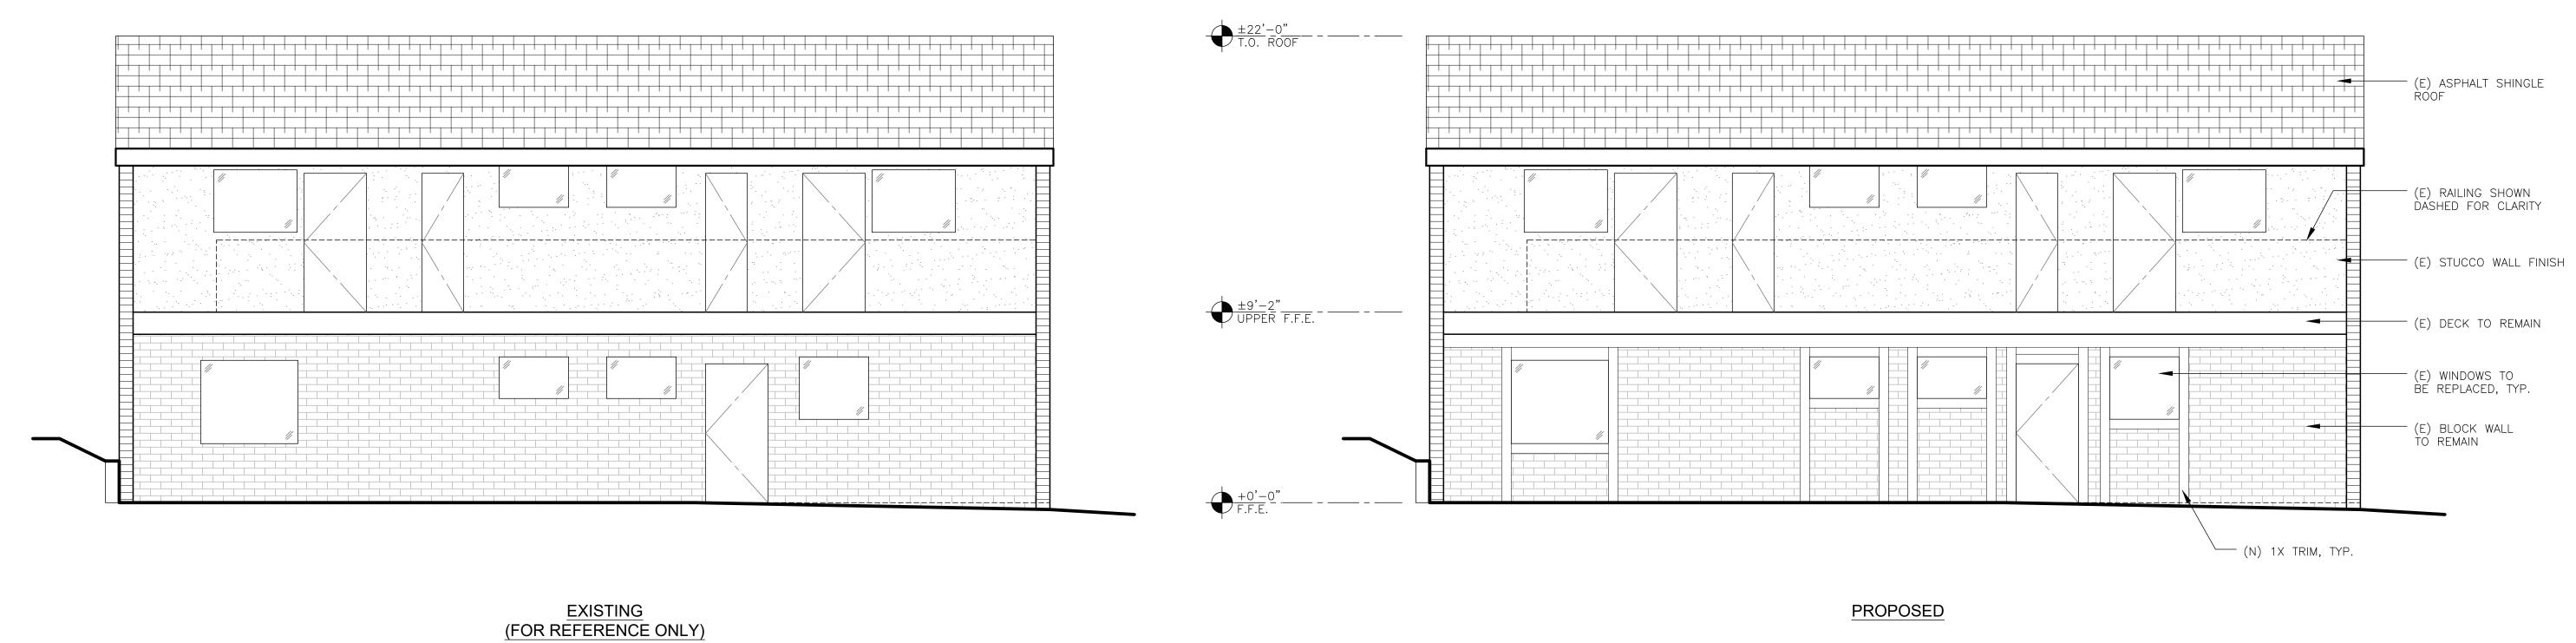


0' 4' 8' SCALE: 1/4"=1'-0" RESIDENTIAL RI 1145, 1147 & 1155 FC PACIFIC GROVE, 0


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SHEET NUMBER

A2
Elevations



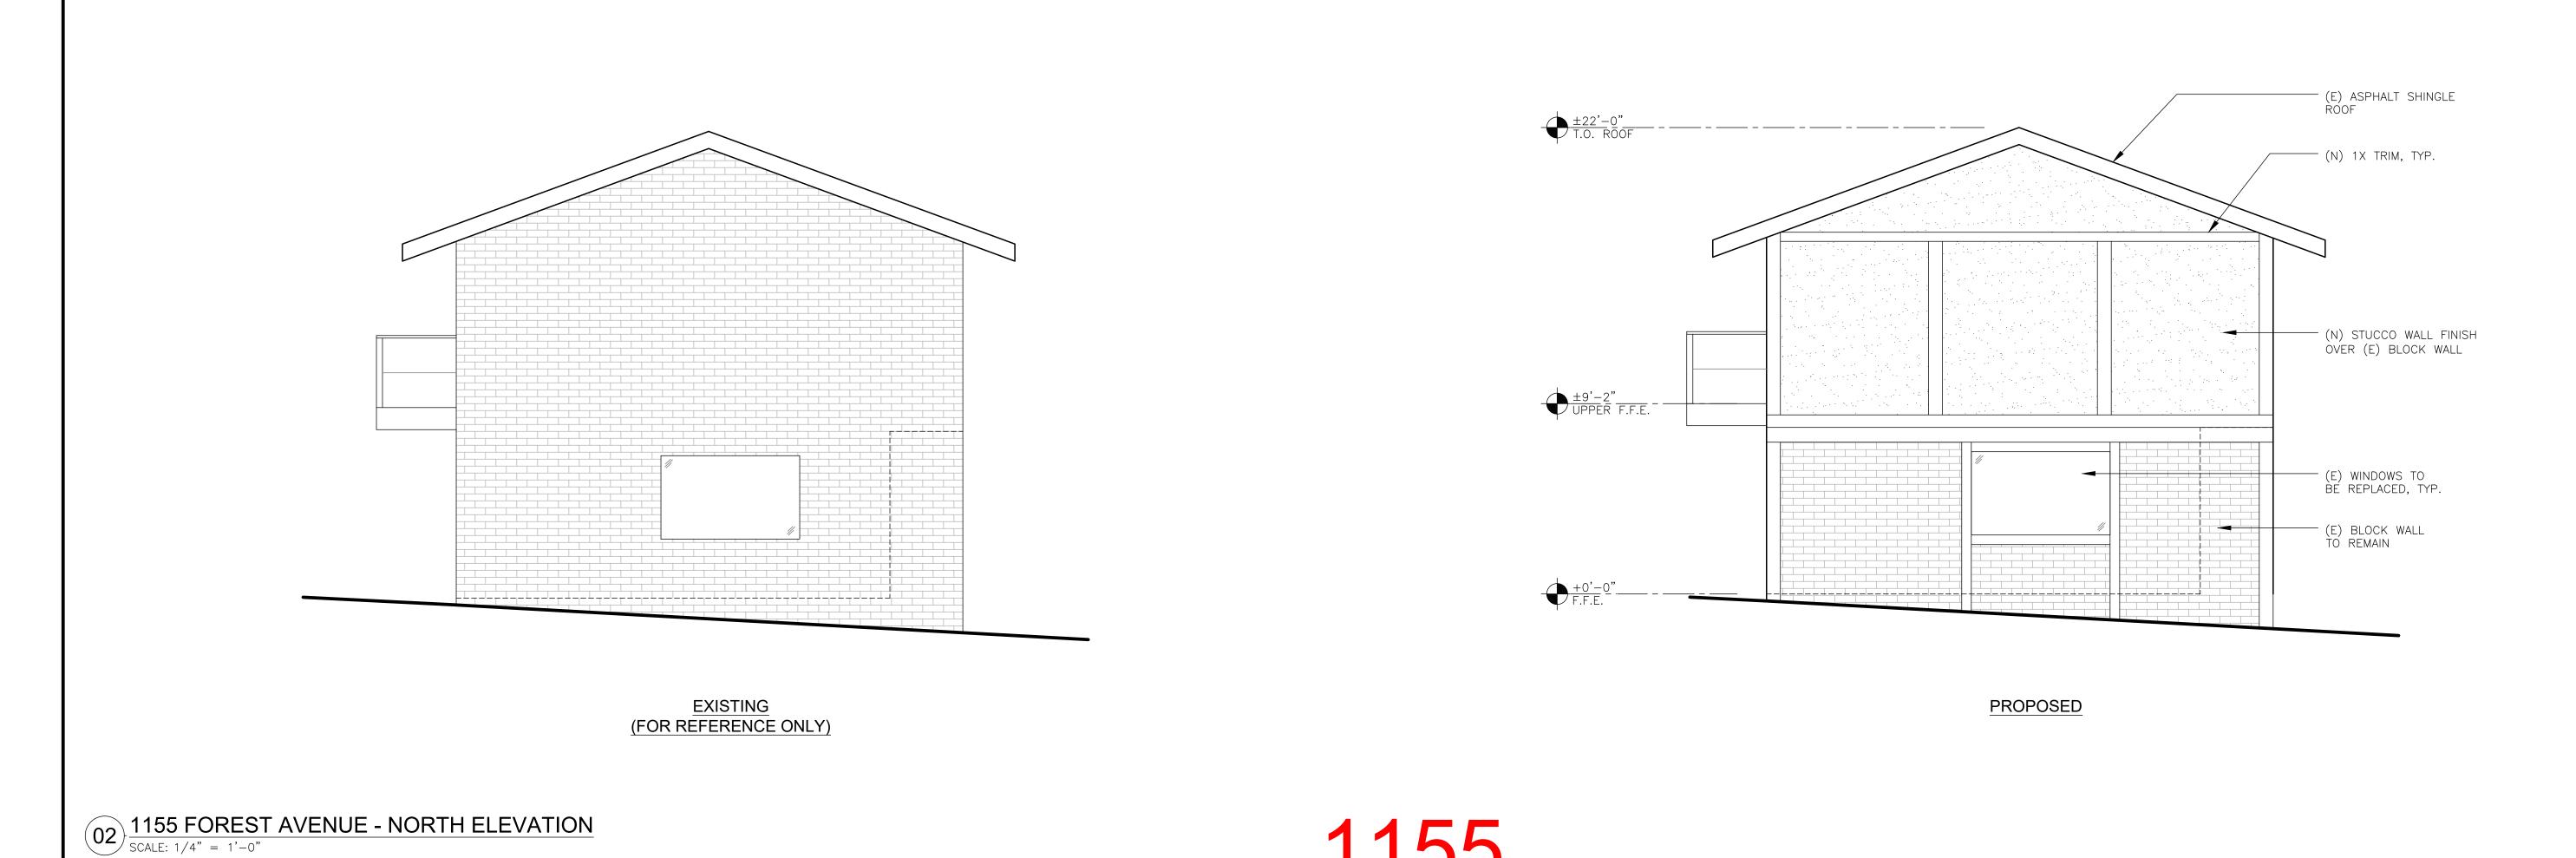


0' 4' 8' SCALE: 1/4"=1'-0" RESIDENTIAL REMODE 145, 1147 & 1155 FOREST AN PACIFIC GROVE, CA 93950

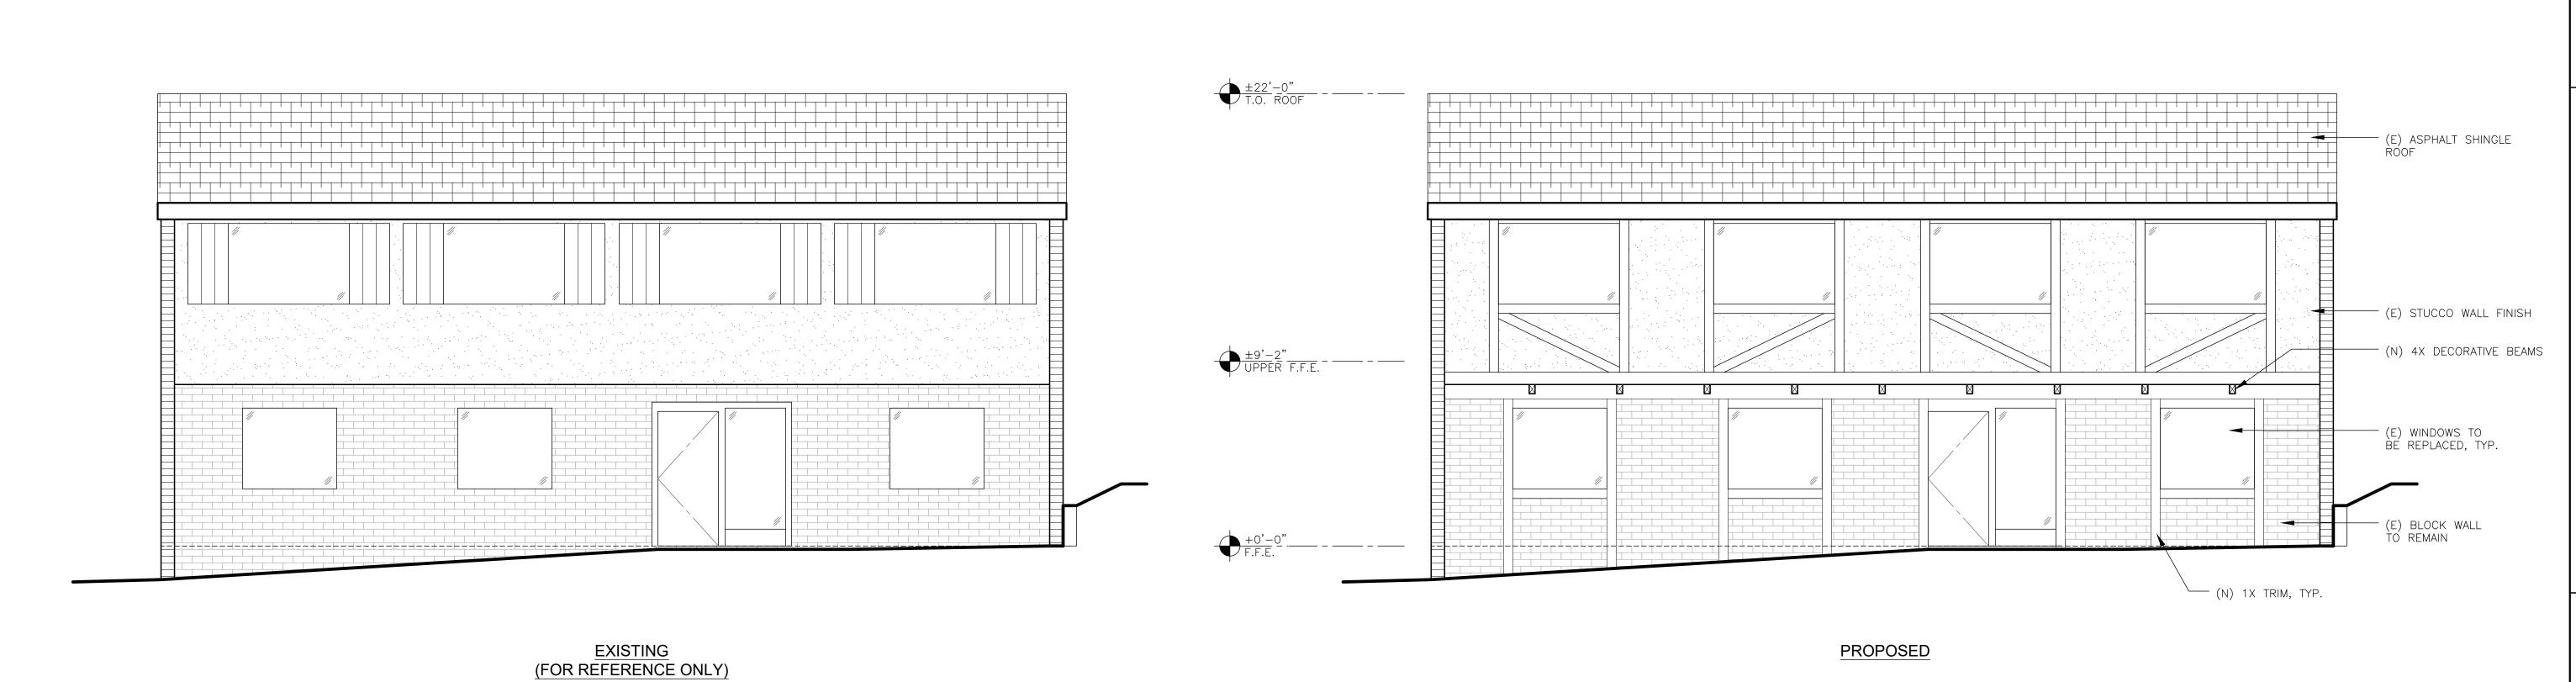KA RESIDENTIAL


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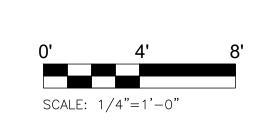
SHEET NUMBER

Elevations

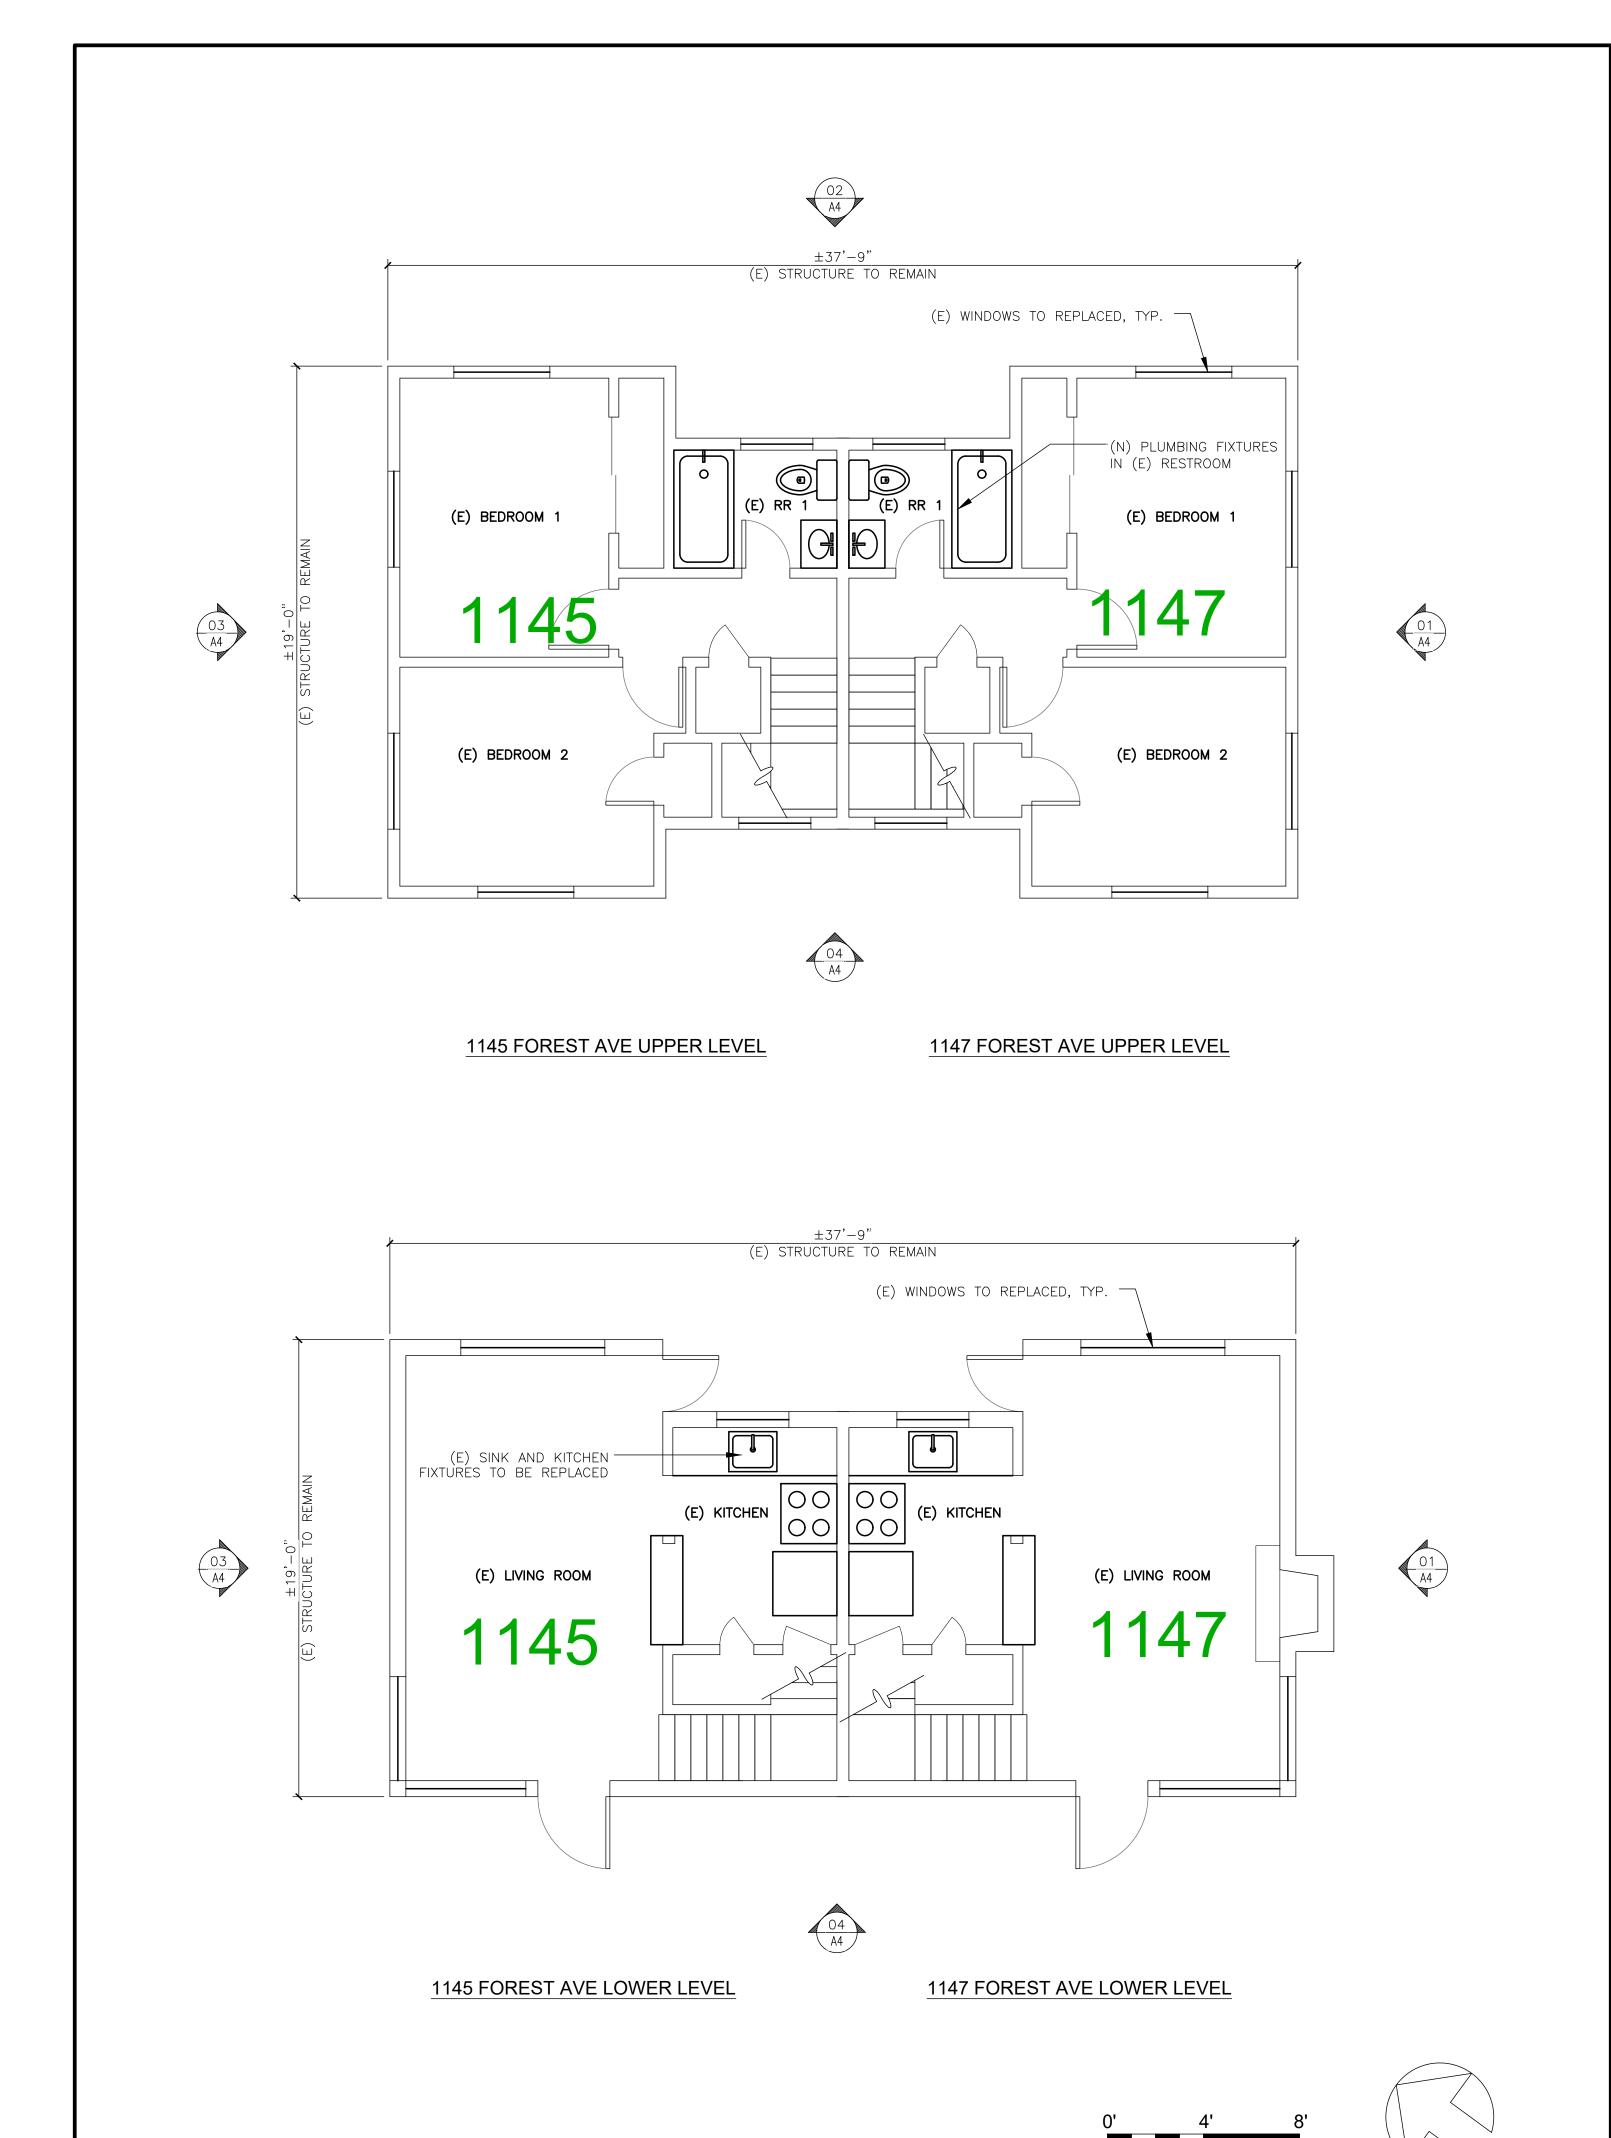

SCALE: 1/4"=1'-0"



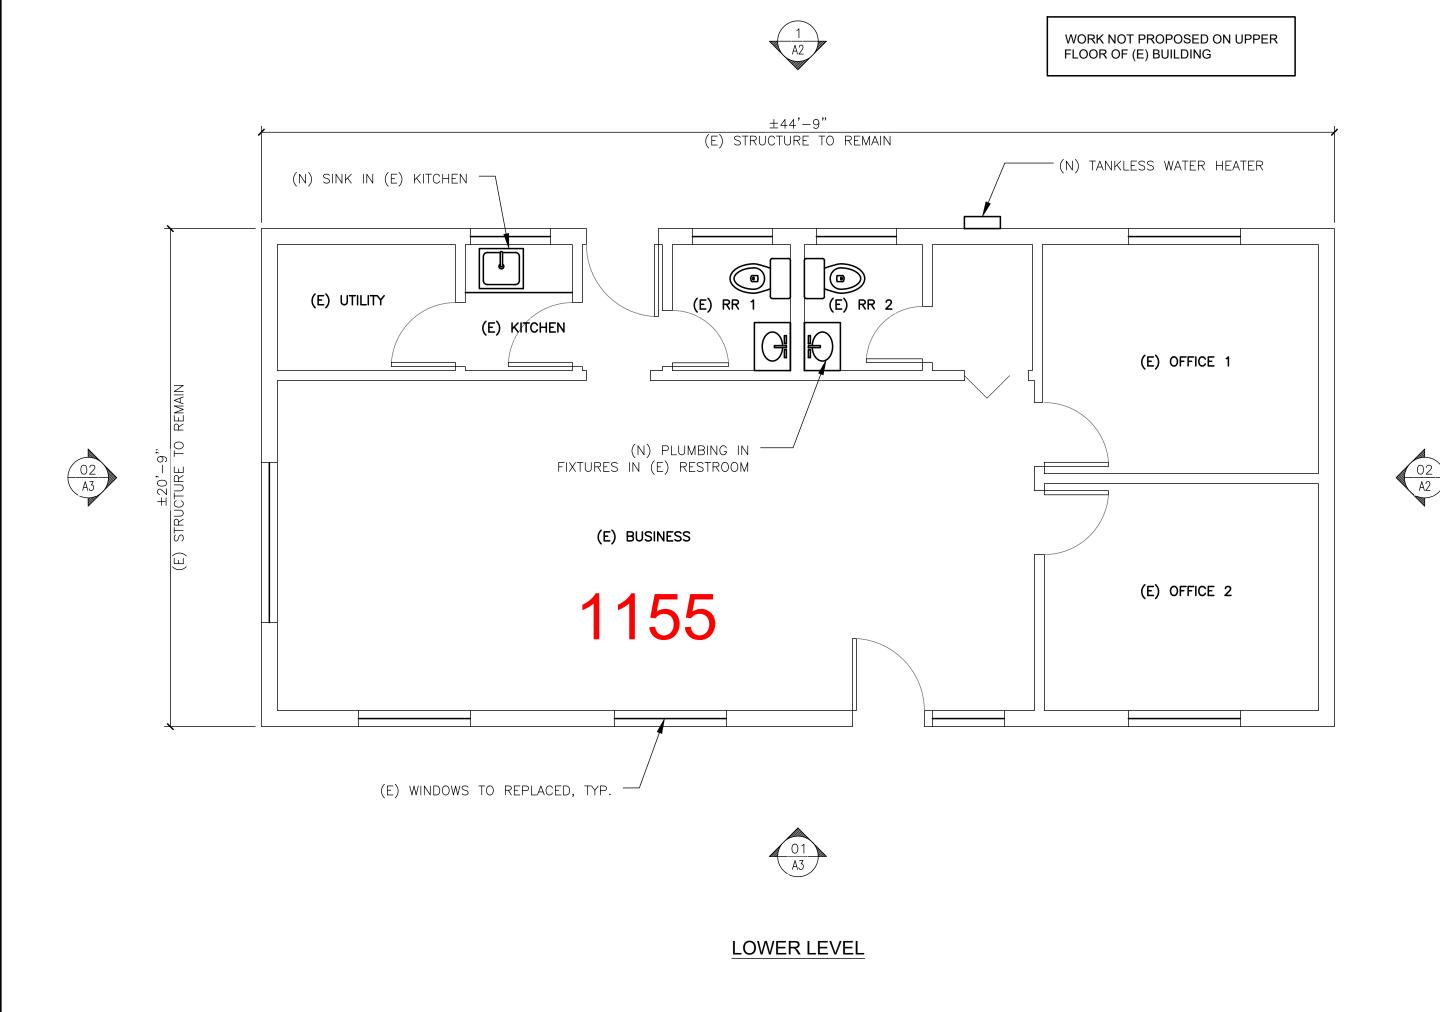





KA RESIDENTIAL

CE

REMODEL FOREST AVE E, CA 93950

RESIDENTIAL R 1145, 1147 & 1155 F PACIFIC GROVE,




KA RESIDENTIAL

RESIDENTIAL REMODEL 1145, 1147 & 1155 FOREST AVE PACIFIC GROVE, CA 93950

SHEET NUMBER

Elevations

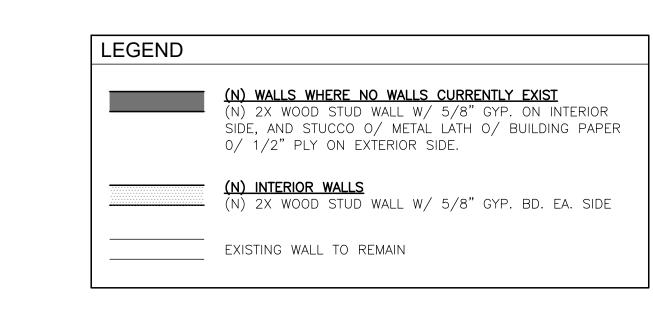

30'-0"
(N) STRUCTURE (N) BEDROOM (N) DECK (N) KITCHEN (N) LIVING ROOM 10'-0"

UPPER LEVEL

New Building #1

30'-0"
(N) STRUCTURE


(N) 3 CAR GARAGE

20'-0"

LOWER LEVEL

(N) STORAGE

10'-0"

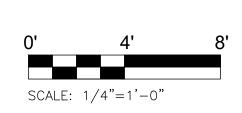



M A N A G E M E N T , L L C
4405 BROOKSHIRE CIRCLE, SANTA ROSA, CA 95
ERNEST@WEAREGATHER.COM 707.494.8857

SOM RESIDENTIAL

KA RESIDENTIAL, LLC
50 WOODSIDE PLAZA #313
REDWOOD CITY, CA 94061
MARK ABRAHAMS
FEL. 707 815 0324

AAWING ISSUED FOR PLANNING


DENTIAL REMODEL 147 & 1155 FOREST AVE FIC GROVE, CA 93950

SHEET NUMBER


H Building 1





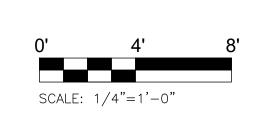



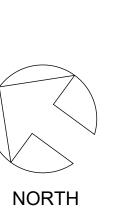

KA RESIDENTIAL

CE

SHEET

NUMBER

Building 2

